



Bid Bulletin No. 2 20 November 2020


PUBLIC BIDDING No. 20-038-1

Construction of New Clark City Connecting Road to Industrial Park

Issued pursuant to Sec. 22.5 of the IRR of R.A. 9184 to clarify and/or amend certain provisions in the Bidding Documents issued for this project, considering the issues raised and clarifications made by prospective bidders during the Pre-Bid Conference held on **October 28, 2020,** likewise, respond to bidders' written queries received within the prescriptive period for filing.

CLARIFICATIONS

No.	CONCERN	REFERENCE	CLARIFICATION/ RESOLUTION
Chin	a Harbour Engineering Company		
1.	Please update the completion progress of right of way.	Right of Way	No right of way acquisition of the project since the property is under BCDA ownership.
2.	During site inspection, the road will cross plenty of rice field, please confirm BCDA will be responsible for the land acquisition.	Right of Way	BCDA is responsible for the road right of way acquisition.
3	During site inspection, the road will cross several creeks, which will be		The winning contractor shall be responsible for their own methodology throughout the implementation of the
	backfilled with embankment as per the drawings, at the same time, a waterway is planned beside the road. Is the waterway will be constructed before the road?	Right of Way	Project. The Contractor shall also be solely responsible for their program and methodology for all the works required that will be considered to prepare their bids intelligently.
4	Kindly request the geotechnical investigation data and report	Geotechnical Investigation	Geotechnical Investigation Data and Report will be provided only to the winning bidder.

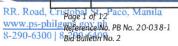





5	Kindly request editable copy of BOQ and Bidding Forms	BOQ	Please refer to Bid Bulletin No. 1. However, in case of any discrepancy/ies between the editable version and the issued PDF version, the latter shall govern. The BAC and the Procuring Entity for any omissions made by the bidder in accomplishing this form.
6	Kindly request the drawings in "Auto Cad" version	Drawings	The Detailed Engineering Design (DED) of the Project in Auto CAD format will only be provided to the Winning Contractor during the Project implementation.
7			Yes. BCDA shall determine the location of the site area for the use of
			Contractor, free of charge. However, all the contractor's temporary facilities, required works,
	Is there any area to be provided by BCDA for contractor to build the temporary facilities, e.g. living camp, site office and stocking yard.	Temporary Facilities	necessary permits, application and payment for utilities shall be at the cost of the Contractor.
8	Please confirm the relevant permit of the project construction work shall be applied and secured by the Client, which may include the building permit, tree cutting permit and etc.	Permits	All necessary and required permits ,and its corresponding costs, for the Project shall be applied and secured by the Winning Contractor.

	DI :c II	T	
9	Please specify the progress payment schedule, Is it monthly progress payment?	Progress payment	Yes.
10	For BOQ items Part C item 102(2) Surplus Common Excavation, please specify the distance of disposal area.	BOQ	Disposal area for the surplus excavated materials will be located in a designated area within the limits of the Project.
11	For BOQ items Part E item 311(1) f1 PCC Pavement, Please specify the strength of concrete.	BOQ	28 MPa shall be used.
12	For BOQ items Part G item 404(1)b and 405(1)a3, Please clarify are the quantities of rebar and concrete cover the STORM DRAIN(RCBC type) and Manhole?	BOQ	Storm Drain and Manhole will be paid in linear meter and in each, respectively. This includes all the materials, labor and equipment to complete the work.
13	Please specify the concrete strength of RCBC storm drain, Manhole and concrete curb.	BOQ	20.68 MPa shall be used.
CM F	Pancho Construction		
14	1. Who will provide the temporary facilities, the Employer or the Contractor? 2. If the Contractor will provide the Temporary Facilities, to what particular pay item shall we include the provision of temporary facilities?	Part A. Facilities for the Engineer As specified in Clause A.1.1.2.a Temporary Office "The Employer shall provide the temporary field office building for the Engineers initial use while the permanent field office building is under construction for 4 month period.	The Employer will provide the temporary facilities for its own Engineer's until such time that Pay Item A.1.1(3) Construction of Field Office Building for the Engineers is completed or 4 months from the issuance of Notice to Proceed, whichever comes first.
		The contractor shall provide the	



temporary office with sufficient furniture, fixtures, equipment, appliances, internet service and necessary supplies, with the Engineer's prior approval. Part C. Earthworks 15 Based on the given Bill of Quantities, we have excess materials from the excavation under 1. For bidding purposes, Item 102(2) Surplus the bill of quantities Common Excavation (BOQ) on the Bidding = 157, 581.30 cu.m. Documents will remain as however based on estimated quantity. These the given drawings quantities will be under Part I: subjected to as-stake 1. Please clarify which one is Roadworks, the quantities during correct. summary of implementation. In case Quantities specified there are any changes or 2. Do we have a designated that we have no additional work items disposal area for surplus common Item 102(2) Surplus during implementation, it excavation? If yes, kindly provide Common Excavation will be treated as us the location of designated for this project and Variation Order in disposal area. instead we have accordance with Annex E Item 104(2) of RA 9184 - Contract Embankment from **Implementation** Borrow Excavation, Guidelines for the Common Soil = 132, Procurement of 549.01 cu.m. In Infrastructure Projects. addition, based on the given profile and cross section, we 2. Disposal area for the surplus excavated can conclude that materials will be located there is more fill section than cut in designated areas section for this within the limits of the Project. project.

		Part E. Surface	
16			
		Course	
		Item 311(1)F1 PCCP	
		(unreinforced)	
		0.30m thick	
		Based on the	
		Standard Portland	
	1 Kindly confirmathet we need to		
	1. Kindly confirm that we need to	Cement Concrete	
	install the 36mm dia. x 0.60m @	Typical Plan	
	0.274m O.C. for every 4.5m	(drawing no.	
	transverse construction	PHI-R-404) we need	1. Dowel bars are to be
	joint/weakened plane joints for the	to install Plain	installed for every joint
	carriageway pavement. Previous	Dowel Bars 36mm	for this Project.
	bidded project within New Clark	dia. x 0.60m	•
	City (access road and connecting	@0.274m o.c. for	
	road) does not include this	every contraction	
	specification. Please clarify.	joint (every 4.5m)	
		of the PCCP with	
	2. Kindly provide us also the	corresponding steel	
	specification/tensile strength of	basket for setting	2. Dowel bars shall be at
	Plain Dowel Bars.	dowels.	Grade 40.
1 17		Dight of Way	
17		Right of Way	
17		Right of Way Acquisition	
17		Acquisition	
17		Acquisition We noted during	
17		Acquisition We noted during our group site	
17		Acquisition We noted during our group site inspection that the	
17		Acquisition We noted during our group site	
17	Kindly provide us the status of the	Acquisition We noted during our group site inspection that the	
17	Kindly provide us the status of the ROW acquisition and project target	Acquisition We noted during our group site inspection that the proposed alignment	
17	ROW acquisition and project target	Acquisition We noted during our group site inspection that the proposed alignment of the connecting	Informal settlers are still
17	ROW acquisition and project target date of completion of clear ROW	Acquisition We noted during our group site inspection that the proposed alignment of the connecting road will traverse through agricultural	Informal settlers are still being resolved/settled by
17	ROW acquisition and project target date of completion of clear ROW upon the award of the project to	Acquisition We noted during our group site inspection that the proposed alignment of the connecting road will traverse through agricultural land (rice field and	
17	ROW acquisition and project target date of completion of clear ROW	Acquisition We noted during our group site inspection that the proposed alignment of the connecting road will traverse through agricultural land (rice field and plantation) and	being resolved/settled by
17	ROW acquisition and project target date of completion of clear ROW upon the award of the project to	Acquisition We noted during our group site inspection that the proposed alignment of the connecting road will traverse through agricultural land (rice field and plantation) and although BCDA is	being resolved/settled by
17	ROW acquisition and project target date of completion of clear ROW upon the award of the project to	Acquisition We noted during our group site inspection that the proposed alignment of the connecting road will traverse through agricultural land (rice field and plantation) and although BCDA is the owner of the	being resolved/settled by
17	ROW acquisition and project target date of completion of clear ROW upon the award of the project to	Acquisition We noted during our group site inspection that the proposed alignment of the connecting road will traverse through agricultural land (rice field and plantation) and although BCDA is the owner of the land, there are	being resolved/settled by
17	ROW acquisition and project target date of completion of clear ROW upon the award of the project to	Acquisition We noted during our group site inspection that the proposed alignment of the connecting road will traverse through agricultural land (rice field and plantation) and although BCDA is the owner of the land, there are several tenants	being resolved/settled by
17	ROW acquisition and project target date of completion of clear ROW upon the award of the project to	Acquisition We noted during our group site inspection that the proposed alignment of the connecting road will traverse through agricultural land (rice field and plantation) and although BCDA is the owner of the land, there are several tenants along the propose	being resolved/settled by
17	ROW acquisition and project target date of completion of clear ROW upon the award of the project to	Acquisition We noted during our group site inspection that the proposed alignment of the connecting road will traverse through agricultural land (rice field and plantation) and although BCDA is the owner of the land, there are several tenants along the propose alignment which will	being resolved/settled by
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17	ROW acquisition and project target date of completion of clear ROW upon the award of the project to	Acquisition We noted during our group site inspection that the proposed alignment of the connecting road will traverse through agricultural land (rice field and plantation) and although BCDA is the owner of the land, there are several tenants along the propose alignment which will	being resolved/settled by

		target completion of	
		the project.	
18	We would like to clarify if BCDA will provide a lot area near the project site for facilities of the winning contractor free of rental charge?	Facilities for the Winning Contractor	Yes. BCDA shall determine the location of the site area for the use of Contractor, free of charge. However, all the contractor's temporary facilities, required works, necessary permits, application and payment for utilities shall be at the cost of the Contractor.
19	Kindly confirm that the reinforcement and thickness of the wall and slab for the lateral RCBC will be the same as to the tabulation provided for the Single Barrel Box Culvert?	Part G: Drainage and Slope Protection Storm Drain (RCBC Type)	Details are the same with the details provided for Single Barrel RCBC.
20	Kindly provide us of the detailed plan of the manhole	Manhole There are eleven (11) types of manhole in the given Bill of Quantities, however, the given plan for the manhole is incomplete and no details for reinforcement, wall thickness, etc	Please see attached revised Drawing No. PH1-D-325 attached as Annex A.
21	We noted that in the Bill of Quantities for Waterway Channel, there is no pay item of Structure Excavation. Please clarify.	Waterway Channel, Sta 0+00 to Sta 1+200 (L=1,288.32)	The quantity for the channel excavation is included in the Roadway Excavation quantities.
22	Since the Stamped Concrete pattern and color will follow the Pedestrian/Sidewalk already constructed in new clark city, may we request for the sample plan of	Part H. Miscellaneous Structures SPL 601(2)1	1. Please see illustration attached as Annex B.



completed section for our Sidewalk/Pedestrian 2. The reinforcement is 10mm diameter at reference? Lane Paving (Reinforced) 100mm 400mm spacing both 2. Kindly confirm that the thick with Stamped ways. reinforcement is 10mm dia. at Concrete Finished **Texture** 400mm spacing bothways for sidewalk and bike lane. 3. Please see illustration SPL 601(2)2 Bike attached as Annex C. 3. Kindly indicate in the plan the Lane Paving location of the expansion joint filler (Reinforced) 100mm 5mm thick and the control joints. thick with Sand 4. Please see Bikeway Washed Finished Finish attached as Annex 4. Kindly provide us also the plan Texture D. for Bike Lane paving with Sand Washed Finished Texture including the details and spacing of required 5. Please see Bikeway diamond dowels to provide load Finish attached as Annex transfer. 5. Kindly provide us also the Section details showing the thickness of concrete, thickness of sand washed or stamped concrete for bike lane paving and sidewalk paving 23 Part J. Roadway Lighting 1. Kindly confirm that in lieu of sand bedding it will be concrete 1. Ducting for road Concrete encasement since this is for road crossing is concrete Encasement crossing encased. (Reinforced) 2. What is the concrete 2. 20.68MPa shall be Item 624(8)b1 Duct compressive strength of concrete used. Banks (Concrete encasement? Encasement) 10.0m 3. Please see revised Single and Double 3. Kindly provide us the detail of Drawing No. PH1-PS-23 Arm Pole for Road reinforcement for concrete attached as Annex E. Crossing encasement which are not included in the given plan 4.Concrete tile is plain Based on the given concrete. drawing detail 4 of 4. Kindly confirm also that the PHI-PS-21, the concrete tile 50mm thick x 250mm scope of works W x 250mm L is unreinforced include excavation

		for trench, placing	
		of sand bedding,	
		placing of concrete	
		tile 50mm thick x	
		250mm W x 250mm	
		L, installation of	
		early warning tape	
		and backfilling	
		works for trench.	
24	Kindly provide detailed plan and	Item 625(8)b	Please refer to Drawing
	specification for this item	Battery Handhole	No. PH1-PS-20 to 22.
Chin	 a Geo Engineering (Phil) Corporat	tion	
			The drawings for Part G:
			Drainage and Slope
25			Protection Structures are
			included in Drawing Part
			2: Drainage System.
		David Co Dualina aa	
		Part G: Drainage	
		and Slope Protection	The drawings for Part H.
	Request for complete details of	Structures	The drawings for Part H: Miscellaneous Structures
	plans	Part H:	are included in Drawing
		Miscellaneous	Part 1: Road Works
		Structures	
		Part J: Roadway	The drawings for Part J:
		Lighting	Roadway Lighting are
			included in Drawing Part
			3: Electrical System
		List of Equipment,	
		Owned or Leased	
		and/or Under	
26	Request for corrected form	Purchase	
		Agreement, Pledged	Please refer to bidding
		to the Contract to	forms issued under Bid
		be Bid	Bulletin No. 1
RII	Builders		1
	Please provide the following		1 For landsening
27	drawings:	General	1. For landscaping drawings, please see
		55.76741	a.a.m.gs, picase see



	Landscaping Drawings Living quarters and laboratory for the engineer		drawings PH1-LS-01 to PH1-LS-09. 2.The living quarters and laboratory shall be constructed in accordance with the location, floor plans and drawings prepared by the Contractor and approved by the Engineer
28	Please provide the following drawings: 1. PH1-D-292 (Curb Inlet, Box Culvert & Junction Box Details) 2. PH1-D-295 (Typical Culvert and Curb Inlet Details)		1. Please see revised Drawing No. PH1-D-325 attached as Annex A. 2. Please see revised Drawing No. PH1-D-325 attached as Annex A.
	3. PH1-D-298 (Waterway General Plan)	Drainage System	3. Please refer to the drawing PH-D-328.
29	Type of XLPE Cables, shielded or unshielded?	Electrical Works	Unshielded
30	Can we offer integrated LED fixtures against conventional type as per requirements?	Electrical Works	The requirement is Integrated LED Fixtures.
31	Can you provide foundation detail of Panel Foundation pad?	Electrical Works	Please see drawing PS1-PS-23 attached as Annex E.
32	Can you identify our limit of scope of our work from Panel Board (Bottom Feed) to transformer if include duct bank works/termination going to Transformer?	Electrical Works	The limit of scope of work is in the Panel Board
33	Do we include in our offer Remote Monitoring of Road Lightings?	Electrical Works	Yes
34	Detail Plan of Battery Handhole? Is this Pole mounted or underground?	Electrical Works	Please refer to drawings PH1-PS-20 to PH1-PS-22.
JC R	odriguez		1



35	Contents reflected in the ff forms of Bidding Documents soft and hardcopy is not complete: 1. Ongoing Government and Private Contracts 2. Single Largest Completed Contract 3. List of Equipment 4. List of Key Personnel	Technical Component	Please refer to bidding forms issued under Bid Bulletin No. 1
36	Please provide sample form for statement of availability for equipment	Technical Component	Please refer to bidding forms issued under Bid Bulletin No. 1
37	May we request for the project post-qualification schedules	Technical Component	Please refer to Instruction to Bidders, Clause 28 - Post-Qualification (Page 30) for the Post-qualification procedure and duration.
38	Based on ITB Clause 24.7, submission of documents required under ITB Clauses 12.1(a)(ii) to 12.1(a)(iv) (NFCC) by any of the joint venture partners constitutes compliance, we would like to confirm if only one of the JV partners must submit an NFCC computation?	Technical Component	Yes. For NFCC computation, the JV can submit at least one computation from any of the JV partners. However, for the purpose of evaluation, the submitted NFCC computation shall be substantiated with the Statement of All Ongoing Contracts and Audited Financial Statement.
39	Do all parties in a JV must submit Bid Securing Declaration and Omnibus Sworn Statement?	Technical Component	The Joint Venture shall submit Bid Securing Declaration and Omnibus Sworn Statement as a single entity, signed by the representative authorized by both parties.



40	For ITB Clause 12.1(b)(i) to (iii) and curiculum vitae, do the authorized representative to all parties in a JV must sign the designated signatory of the forms? For Curiculum Vitae form given for	Technical Component	Only the authorized representative of the Joint Venture must sign the forms.
	the personnel, do all parties' company name must be present at the certification of the personnel at the end of the form?	Technical Component	The name of the Joint Venture, as a single entity, shall be present.
42	Do the authorized representative of all parties in a JV must sign all documents?	Technical Component	Only the authorized representative of the Joint Venture must sign the forms.
43	We would like to confirm what method will be used for the accomplishment billing, indicated in the BDS ITB Clause 2 that payment will be composed of 10% advance payment followed by the progress payments while indicated in the cashflow milestone is that payment will be composed of 10% advance payment and with quarterly		Terms of payment will be composed of: a) 10% advance/mobilization
	schedule for the accomplishment billing	Financial Component	b) Progress Payments
JD L	egaspi Construction		
44	Request Letter	Request for Extension	Schedule of the deadline for submission and opening of bid to be retained.
Chin	a Geo Engineering (Phil) Corporat	ion	
45	We would like to ask a question involving special PCAB license requirement for Joint Ventures. Is it allowed if we submit first the receipt from applying for a Special PCAB License and then afterwards, submit the special pcab license		No. The JV shall submit the Special PCAB License during the opening of
Page 11	itself?	PCAB License	bids.




All other portions of the Bidding Documents affected by these amendments shall be made to conform to the same.

Amendments/inclusions/clarifications made herein shall be considered an integral part of the Bidding Documents.

The changes made in the Philippine Bidding Documents (5th Edition, August 2016) are deemed integrated in the terms and conditions for this project.

MR. DICKSON T. PANTI Chairperson, Bids and Awards Committee I


ANNEX A

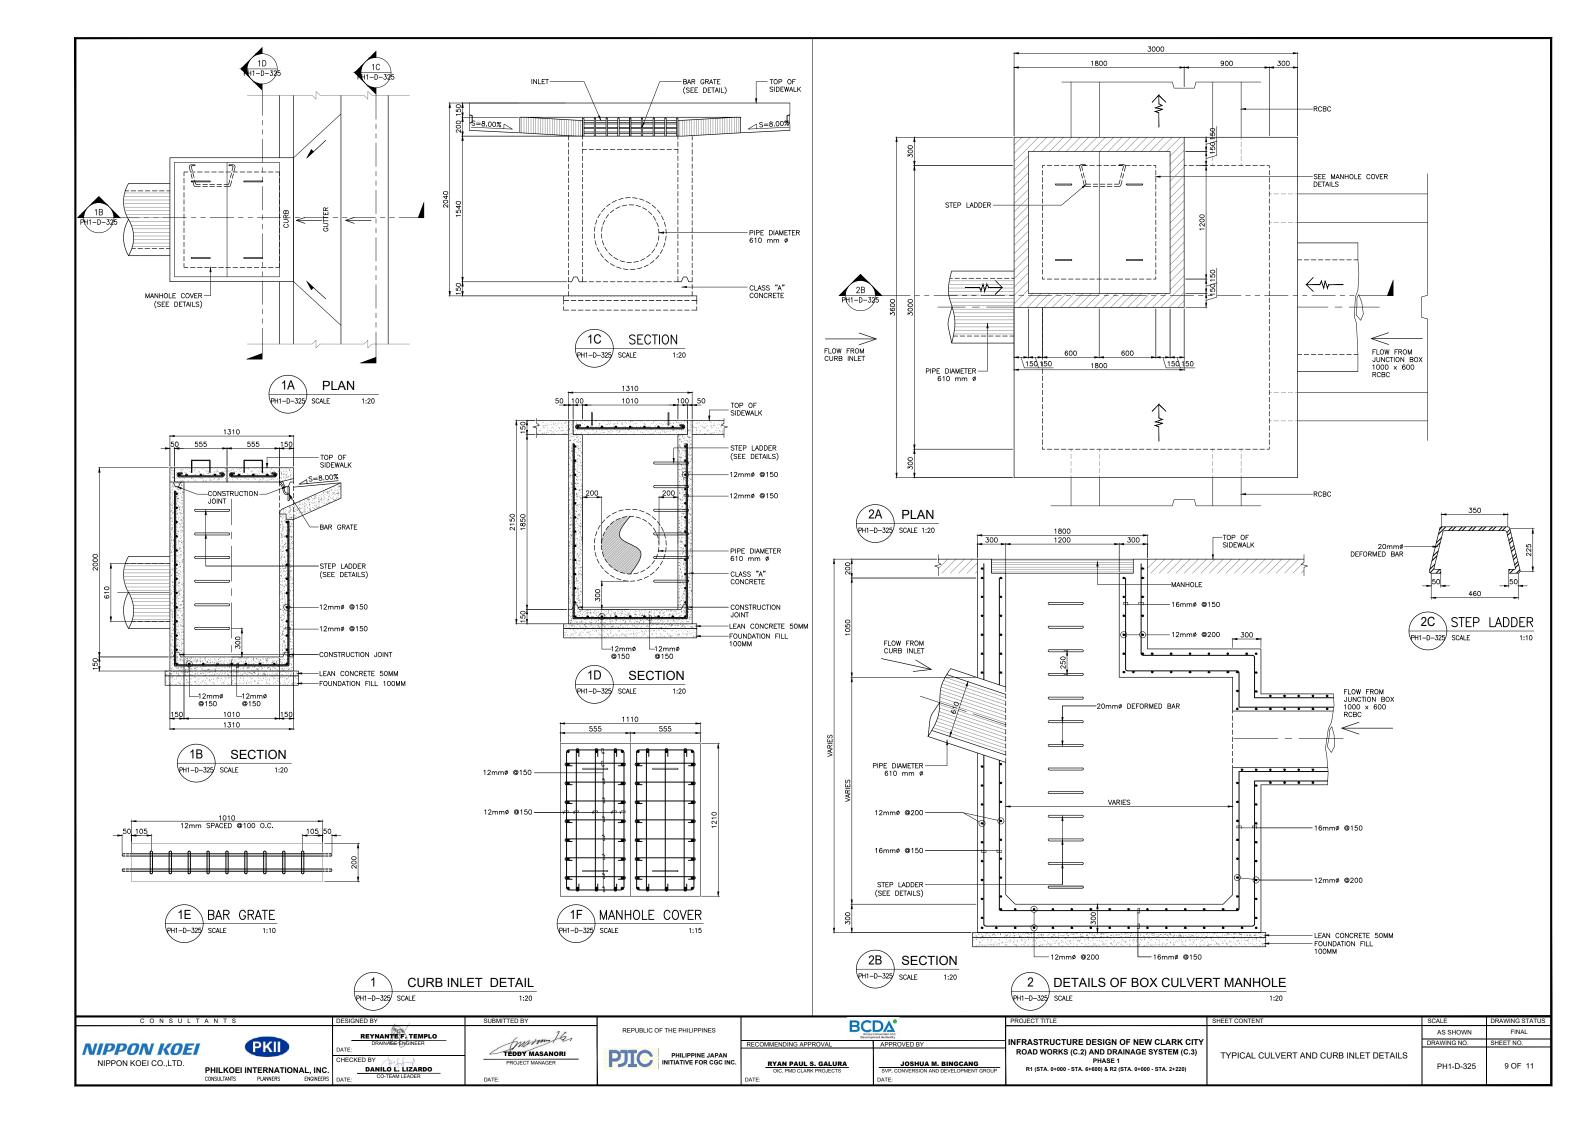

ANNEX B



ANNEX C

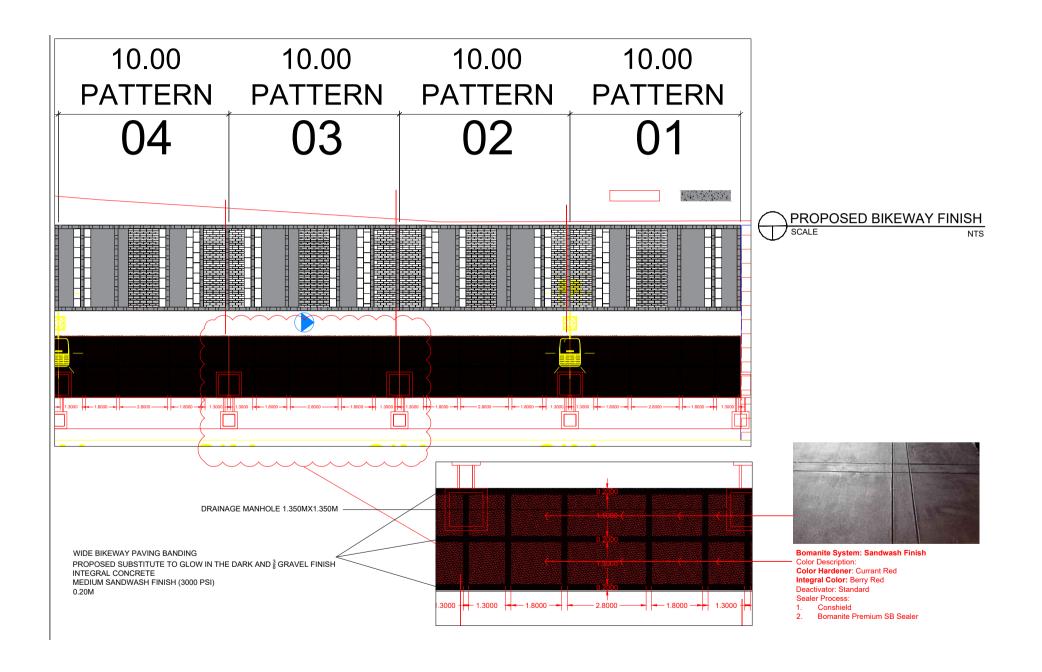

ANNEX D

Project Name: **NEW CLARK CITY (BIKE LANE)**

Location: **TARLAC CITY** System: **SANDWASH**



Bomanite System: Sandwash Finish

Color Description:


Color Hardener: Currant Red Integral Color: Berry Red Deactivator: Standard

Sealer Process:


1. Conshield

2. Bomanite Premium SB Sealer

ANNEX E Part 1

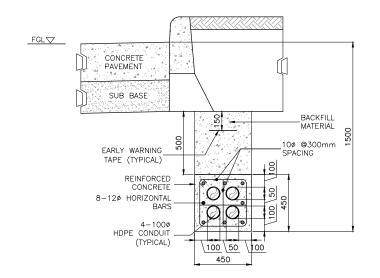



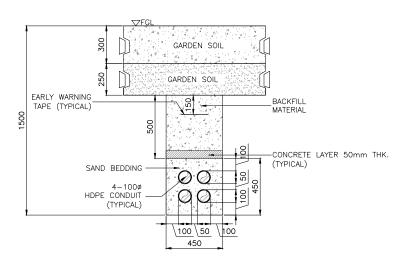


LOW VOLTAGE DIRECT BURIAL POWER CABLE IN HDPE CONDUIT (FOR ICT NON-ROAD CROSSING)


1:15

950 750 370 370 370 100¢ CONDUIT PIPE (TYPICAL) 6A 370X644



MM

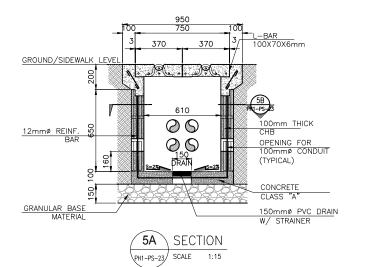

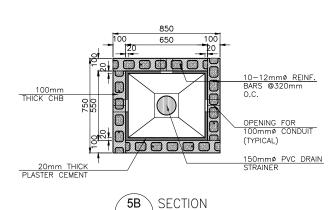

PH1-PS-23 SCALE 1:15

NIPPON KOEI
NIPPON KOEI CO.,LTD.

PHILKOEI INTERNATIONAL, INC.

CHARLES P. PANTE
ELECTRICAL ENGINEER

KED BY

DANILO L. LIZARDO

CO-TEAM LEADER

DATE:

SUBMITTED BY

SUBMITTED BY

FROJECT MANAGER

DATE:



DECDES OF THE PROPERTY OF T

PROJECT TITLE

INFRASTRUCTURE DESIGN OF NEW CLARK CITY
ROAD WORKS (C.2) AND DRAINAGE SYSTEM (C.3)
PHASE 1
R1 (STA. 0+000 - STA. 6+000) & R2 (STA. 0+000 - STA. 2+220)


NOTES

- PIPE THICKNESS IS 3.0mm.
 STRUCTURAL MATERIALS TUBULAR STEEL
 IN HOT-DIPPED GALVANIZED W/ BASE
 PLATE (SQUARE) 10.5" (267mm)
- 2. POLE HEIGHT 10m WITH DOUBLE ARM 1.8m
- POLE HEIGHT 6m WITH DOUBLE ARM 1.0m W/ BASE PLATE (SQUARE) 10" (254mm)
- 4. ANCHOR BOLTS SIZE: 3/4"(20mm) X 34.4" (900mm) LENGTH X 4" (100mm) hook dio. CONTRACTOR TO VERIFY FROM POLE MANUFACTURER ACTUAL MOUNTING DIMENSION OF ANCHOR BOLT PLACEMENT PRIOR TO CONCRETING WORKS.
- 5. ANCHOR BOLTS SIZE: 11/16"(18mm) X 27'9/6" (700mm) LENGTH X 4" (100mm) hook dia. CONTRACTOR TO VERIFY FROM POLE MANUFACTURER ACTUAL MOUNTING DIMENSION OF ANCHOR BOLT PLACEMENT PRIOR TO CONCRETING WORKS.
- A. REINFORCED CONCRETE 3,000 PSI, 3/4 AGGREGATES 28 DAYS
- B. SCHEDULE OF REINFORCING BARS


DIAMETER OF BARS	GRADE	ASTM
ø12 AND SMALLER	GRADE 40	A706M
(WELDABLE)	(40,000psi)	PNS49
ø16 AND LARGER	GRADE 60	A706M
(WELDABLE)	(60,000psi)	PNS49

- C. ASSUMED SOIL BEARING CAPACITY =100 KPA
- D. WIND SPEED = 260 KPH

ANNEX E Part 2

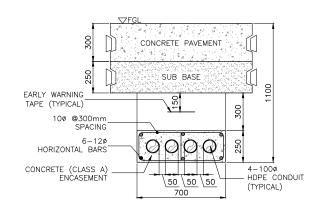


6M DOUBLE ARM POLE LOW VOLTAGE DUCTBANK DETAIL FOR ROAD CROSSING — ROAD LIGHTING CABLE PHI-PS-23 SCALE 1:15

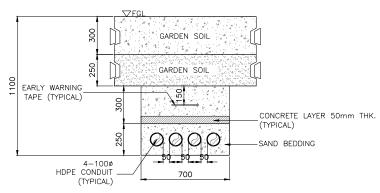


6M DOUBLE ARM POLE LOW VOLTAGE DIRECT BURIAL POWER CABLE IN HDPE CONDUIT (FOR NON-ROAD CROSSING)


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HANDHOLE PLAN
PH1-PS-23 SCALE 1:15

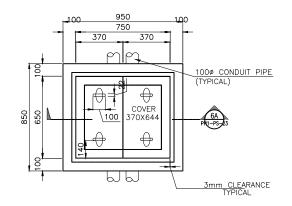


10M SINGLE AND DOUBLE ARM POLE LOW VOLTAGE POWER CABLE IN REINFORCED CONCRETE (FOR ROAD CROSSING)

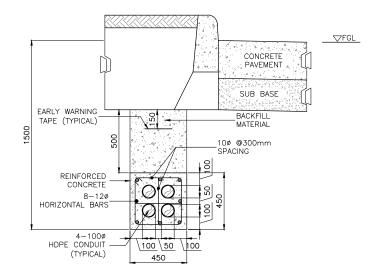


10M SINGLE AND DOUBLE ARM POLE
LOW VOLTAGE DIRECT BURIAL POWER CABLE IN HDPE CONDUIT
(FOR NON-ROAD CROSSING)

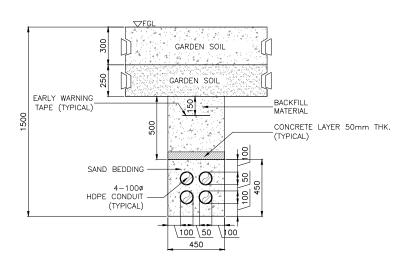
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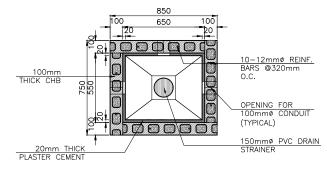
PH1-PS-23 SCALE 1:15

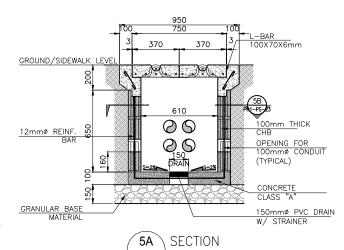



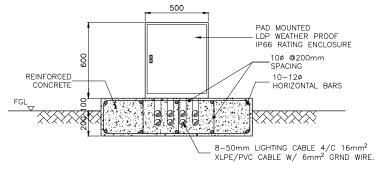



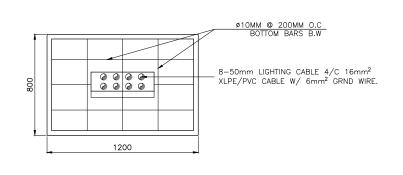

SECTION

PH1-PS-23 SCALE 1:15

NIPPON KOEI NIPPON KOEI CO.,LTD.

PH1-PS-23 SCALE





1:15



BCDA* Designed Authory Conference Authority			
ECOMMENDING APPROVAL	APPROVED BY		
RYAN PAUL S. GALURA	JOSHUA M. BINGCANG		
OIC, PMD CLARK PROJECTS	SVP, CONVERSION AND DEVELOPMENT GROUP		
ATF:	DATE:		

INFRASTRUCTURE DESIGN OF NEW CLARK CITY ROAD WORKS (C.2) AND DRAINAGE SYSTEM (C.3) PHASE 1
R1 (STA. 0+000 - STA. 6+600) & R2 (STA. 0+000 - STA. 2+220)

HANDHOLE, DUCTBANK 8	
LDP FOUNDATION DETAIL	S

NOTES

- PIPE THICKNESS IS 3.0mm. STRUCTURAL MATERIALS TUBULAR STEEL IN HOT-DIPPED GALVANIZED W/ BASE PLATE (SQUARE) 10.5" (267mm)
- 2. POLE HEIGHT 10m WITH DOUBLE ARM 1.8m
- POLE HEIGHT 6m WITH DOUBLE ARM 1.0m W/ BASE PLATE (SQUARE) 10" (254mm)
- ANCHOR BOLTS SIZE: 3/4"(20mm) X 34.4" (900mm) LENGTH X 4" (100mm) hook dia. CONTRACTOR TO VERIFY FROM POLE MANUFACTURER ACTUAL MOUNTING DIMENSION OF ANCHOR BOLT PLACEMENT PRIOR TO CONCRETING WORKS.
- 5. ANCHOR BOLTS SIZE: 11/16"(18mm) X 27'9/6" (700mm) LENGTH X 4" (100mm) hook dia. CONTRACTOR TO VERIFY FROM POLE MANUFACTURER ACTUAL MOUNTING DIMENSION OF ANCHOR BOLT PLACEMENT PRIOR TO CONCRETING WORKS.

REINFORCED CONCRETE 3,000 PSI,

- 3/4 AGGREGATES 28 DAYS
- B. SCHEDULE OF REINFORCING BARS

DIAMETER OF BARS	GRADE	ASTM
ø12 AND SMALLER	GRADE 40	A706M
(WELDABLE)	(40,000psi)	PNS49
ø16 AND LARGER	GRADE 60	A706M
(WELDABLE)	(60,000psi)	PNS49

- C. ASSUMED SOIL BEARING CAPACITY =100 KPA
- D. WIND SPEED = 260 KPH