	Metro Manila Subway Project Phase 1 PACKAGE CP104: (ORTIGAS NORTH AND ORTIGAS SOUTH)									
ITEN NO.			QUERIES	RESPONSE						
			Volume I Part 1 : Bidding Procedures							
1.	Section II Bid Data Sheet (BDS) BDS-4 ITB 14.7		would like to confirm if payment of documentary for Insurance policy shall also be exempted or not.	The costs of stamp duties and similar charges (if any) imposed by law in connection with entry into the Contract Agreement shall be borne by the Employer.						

	Volume IA Part 1 : Bidding Procedures Section IV Bidding Form-Bill of Quantities (BOQ)								
2.	118	BOQ Items G118(4) is for payment of the Environmental	Item $G118(5)$ is deleted from $BOQ$ .						
	G118(4) G118(5)	Guarantee Fund (EGF) and G118(5) is for the							
	Environmental Monitoring	Environmental Monitoring Fund (EMF).	Please refer to "BOQ Bill No.1" in Annex C of this GBB						
	Fund and Environmental	However in the GS Section 118 there is no mention of the							
	Guarantee Fund.	Environmental Monitoring Fund. Please provide a							
		specification and method of payment for the EMF.							
3.	Discrepancies between the	Please confirm that where quantities on drawings differ	Please refer to the latest BOQ in GBB 10 and GBB11						
	Specifications and the Bills of	from quantities in the BOQ, then unit rates should be							
	Quantity	calculated based on quantities in the BOQ.							
4.	Pay Item 800 Hardscape	We also would like to request for the techical specifications	Concrete pavers, Napoli Stone and Granite Stone have						

			Metro Manila Subway Project Phas PACKAGE CP104: (ORTIGAS NORTH AND ORTIG		ГН)		
ITEN NO.	ITEM REFERENCE/CLAUSE/SECTIO		QUERIES	RESPONSE			
		Does F pay ite F F	Pay item 800 hardscape also refers to the following ems under Bill No 6 - Station Plaza? Please clarify. Pay Item 1057 Concrete Pavers Pay Item Napoli Stone Pay Item 1018 Granite Stone	613 616 614 615 The hard	613 616 614 615 dscape refers to efer to below scr Sc All All All	he under Finishes.   Paver Blocks  300x300x50mm Tactile  Napoli Stone  Granito Tile  the allowances under "Softscape".  reenshot.   offscape owance for Plantboxes owance for Plantboxes owance for Benches owance for Park Furnitures	
5.	Bill of Quantities Bill 7 1018(8)a 300x300mm yellow directional tactile1018(8)b 300x300mm yellow hazard warning tactile	iItem this It	e drawing shown below (SPL-C-RD-OS-1032) is for Pay 1018(8)a and Pay iItem 1018(8)b? Please confirm if tem is Stainless Steel Tactile and what color.			has its own pay item in the BOQ	
6.	Bill of Quantities Bill 5A, Item 1203 (1) STN -MEP-VAC-ON-3811	Please prevai	clarify which of the following conflict items shall l:		CBBB10 uses 10.3 PE-1; Passenger Elev and rear opening, 10.3	99m. valor, 1600kg, 2stops/openings, Front 99m traveling ht, 60 m/m speed, set 1.00	

		PA			ay Project F ORTH AND O	Phase 1 ORTIGAS SOUTH)
ITEN NO.		CTION		QUERIES		RESPONSE
		Descriptio	n As per MEP Pla	As per an Architecto Plan		вод
		North Station ELEV-01 Traveling Hei	10.99 meters ght	Not reflecte	ed 6.3 meters	S
7.	Bill of Quantities Bill 5A, Item 1203 (1)	Please clarify which of the following conflict items shall prevail:				BOQ in GBB10 uses 11.54m.         1203       1203(1)       PE-2; Passenger Elevator, 1600kg, 3stops, 2front / 1rear opening; 11.54m traveling ht, 60 m/m speed       set       1.00
	STN -MEP-VAC-ON-3812,	Description	As per MEP Plan	As per Architectural Plan	As per BOQ	
	STN-AR-ON-9671	North Station ELEV-02 Traveling Heigl	11.54 meters	11.54 meters	19.94 meters	
8.	Bill of Quantities Bill 5A,	Please clari	fy which of the fo	llowing confli	ct items shall	Escalator step width shall be minimum 1000 mm.
	Item 1233 (1)	Description	As per MEP Plan	As per Architectural Plan	As per BOQ	However, BOQ description provides total width of escalator requirements including housing.
	MEP-VAC-ON-3822, MEP- VAC-ON-3823, MEP-AR-A- ON-1001	North Station ESCA 1 & 2 Step width	1010 mm	1000 mm	1550 mm	

		PA			way Project F NORTH AND O	Phase 1 PRTIGAS SOUTH)
ITE NO	1 REFERENCE/CLAUSE/SECTION		QUERIES			RESPONSE
9.	Bill of Quantities Bill 5A,	prevail: Please clarif	y which of the fo	ollowing confl	ict items shall	Escalator step width shall be minimum 1000 mm.
	Item 1233 (1) MEP-VAC-ON-3825, MEP-	prevail: Description	As per MEP Plan	As per Architectural Plan	As per BOQ	However, BOQ description provides total width of escalator requirements including housing.
	VAC-ON-3826, STN-AR-A- ON-1002	North Station ESCA 3 & 4 Step width	1010 mm	1000 mm	1550 mm	Please refer to the MEP Plan Drawing below:           NOTE:           This DRAWING IS NOIGHTIVE ONLY AND FURTHER COORDINATION           WITH RESPECTIVE SCALARDY EVENOR SHALL BE REQUIRED.           TECHNICAL SPECIFICATION VISION FOR THE REPORT OF T
						MOVING HANDRAIL IGHT IGLASS PANEL WORKING LINE UBGHT UNDER HANDRAIL IGHT IGHT IGHT IGHT IGHT IGHT IGHT IGHT

million	<b>11</b>									
	Metro Manila Subway Project Phase 1 PACKAGE CP104: (ORTIGAS NORTH AND ORTIGAS SOUTH)									
ITEM NO.	REFERENCE/CLAUSE/SECTION	QUERIES	RESPONSE							
			METRO MANILA SUBWAY PROJECT     PHASE1     PACKAGE CP 104     Ortigas North Station     Facelator No. 2.8.4 (Sheet 2)	DATE August 2020 SCALE AS SHOWN SHEET No. DRG No. STN-MEP-VAC-ON-3825 DRG S. REV 4						

	Metro Manila Subway Project Phase 1 PACKAGE CP104: (ORTIGAS NORTH AND ORTIGAS SOUTH)								
ITEM NO.	REFERENCE/CLAUSE/SECTION	QUERIES	RESPONSE						
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	Metro Manila Subway Project Phase 1 PACKAGE CP104: (ORTIGAS NORTH AND ORTIGAS SOUTH)									
ITEN NO		E/SECTION QUERIES			RESPONSE					
						METRO MANILA SUBWAY PROJECT PHASE1     DATE SCALE       PACKAGE CP 104     SHEET No.       Ortigas North Station Escalator No. 3 & 4 (Sheet 3)     DRG No. STN-MEP-VAC-ON-3826       DRG S.     REV 4				
10.	Bill of Quantities Bill 5A,		which of the follo	wing conflict i	tems shall	Escalator step width shall be minimum 1000 mm.				
	Item 1233 (1)STN-AR-A-ON-	prevail:				However, BOQ description provides total width of				
	1002 to STN-AR-A-ON-1004, STN-MEP-VAC-ON-3828,	Description	As per MEP Plan	As per Architectural Plan	As per BOQ	escalator requirements including housing. Please Refer to MEP Plan Drawing below				
	STN-MEP-VAC-ON-3829	North Station ESCA 5 - 8 Step width	1010 mm	1000 mm	1550 mm					


	Metro Manila Subway Project Phase 1 PACKAGE CP104: (ORTIGAS NORTH AND ORTIGAS SOUTH)								
ITEM NO.	REFERENCE/CLAUSE/SECTION		QUERIES	RESPONSE					
				NTER         NOTH Station         NTER         NTER         NTER         NTER         NTER         NTER         NTER         NTER         NTER </td					

Metro Manila Subway Project Phase 1 PACKAGE CP104: (ORTIGAS NORTH AND ORTIGAS SOUTH)							
ITEM NO.	REFERENCE/CLAUSE/SECTION	QUERIES	RESPONSE				
			NOTE : THIS DRAWING IS INDICATIVE ONLY AND FURTHER COORDINATION WITH RESPECTIVE ESCALATOR VENDOR SHALL BE REQUIRED. TECHNICAL SPECIFICATION SECTION 1233 NEEDS TO BE REFERRED FOR TECHNICAL PARTICULAR OF ESCALATOR. DURING CONSTRUCTION, ARCHITECTURE (STRUCTURE) CONTRACTOR NEED TO FURTHER COORDINATION WITH SELECTED ESCALATOR VENDOR FOR FIXING ARRANGEMENT OF MOUNTING PLATE.				

		PAC	Metro Ma KAGE CP104: (		y Project Ph DRTH AND OR	
ITEM NO.	REFERENCE/CLAUSE/SE	CTION	ON QUERIES			RESPONSE
	Bill of Quantities Bill 5B, Item 1203 (1) STN -MEP-VAC-OS-3811	Please clarify prevail: Description South Station ELEV-01 Traveling Height	which of the foll As per MEP Plan	lowing conflict As per Architectural Plan Not reflected	items shall          As per BOQ         6.3 meters	METRO MANILA SUBWAY PROJECT       DATE         PHASE1       SCALE         August 2020         SCALE       AS SHOWN         BHEET No.       Driggas North Station         Escalator No. 5,6,7 & 8 (Sheet 3)       DrG No.         STN-MEP-VAC-ON-3829       DrG S.         PRG S.       Ref         August 2020       Ref         As SHOWN       String North         Bread of the string North Station       DrG No.         STN-MEP-VAC-ON-3829       DrG S.         PRG S.       Ref         4       4
	Bill of Quantities Bill 5B, Item 1203 (1) STN -MEP-VAC-OS-3812, STN-AR-OS-9671	Please clarify prevail:	which of the foll	lowing conflict	items shall	Refer to BOQ in GBB 10. It shall be 11.54m.         1203       1203(1)       PE-2; Passenger Elevator, 1600kg, 3stops/openings, front and rear opening; 11.54m traveling ht, 60 m/m speed       set       1.00

Annez	Metro Manila Subway Project Phase 1 PACKAGE CP104: (ORTIGAS NORTH AND ORTIGAS SOUTH)							
ITEN NO		CTION			QUERII	ES		RESPONSE
		Descriptior		As per MEP F	As per Per MEP Plan Architectural As per I Plan		As per	
			outh Station LEV-02 11.54 meters 11.54 meter raveling Height		.54 meters	19.94 met		
13.	Bill of Quantities Bill 5B, Item 1203 (1)	Please clarify which of the following conflict items shall prevail:					Refer to BOQ in GBB 10. It shall be 3steps, 2front/ 1 rear         1203       1203(1)       PE-2; Passenger Elevator, 1600kg, 3stops/openings, front and rear opening; 11.54m traveling ht, 60 m/m speed       set	
	STN-AR-A-OS-9671, STN- MEP-VAC-OS-3812	South Station 3 stops 2 front / 1 3 stops 2 front /					s/ opening	
14.	Bill of Quantities Bill 5B,Please clarify which of the following conflict items shallItem 1233 (1)MEP-VAC-OS-prevail:3822, MEP-VAC-OS-3823,HEP-AR-A-OS-1001			Escalator step width shall be minimum 1000 mm. However, BOQ description provides total width of escalator requirements including housing. Please refer to MEP Plan Drawing Below.				



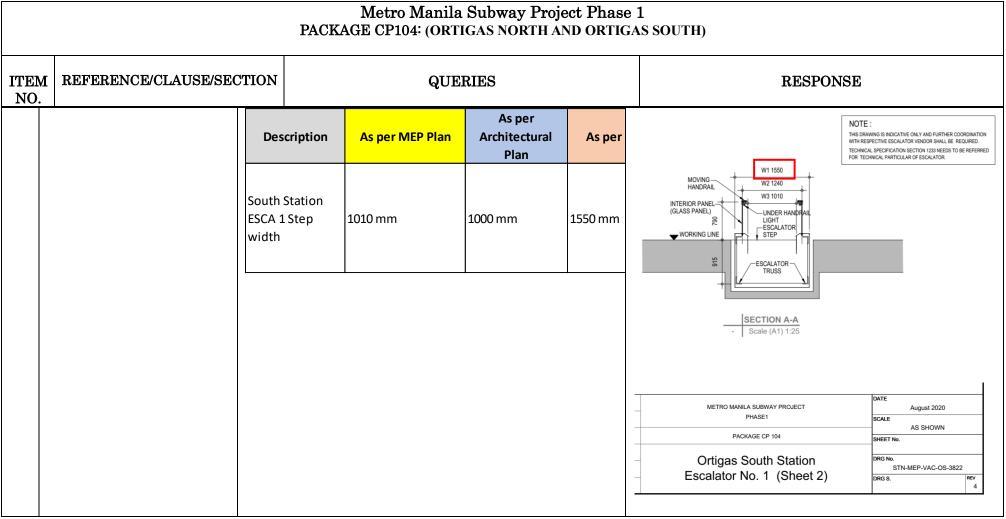



	Metro Manila Subway Project Phase 1 PACKAGE CP104: (ORTIGAS NORTH AND ORTIGAS SOUTH)						
ITEM NO.	REFERENCE/CLAUSE/SECTION	QUERIES	RESPONSE				
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AIIIIe2	Metro Manila Subway Project Phase 1 PACKAGE CP104: (ORTIGAS NORTH AND ORTIGAS SOUTH)						
ITEN NO	I REFERENCE/CLAUSE/SECTIO		CTION QUERIES		RESPONSE		
15.	Pay Item 1032 Painting, Varniching and other Related Works	Anti G	uld like to clarify if all painted areas are required for raffiti Coating. If not, may we request a schedule for raffiti Coating.	not ii 1032.	METRO MANILA SUBWAY PROJECT PHASE1       DATE August 2020         PACKAGE CP 104       SHEET NO.         Ortigas South Station Escalator No. 1 (Sheet 3)       ORG NO. STN-MEP-VAC-OS-3823         graffiti coating on drawings is not identified. TS does nclude Anti-graffiti coating on Products (TS Section .2.1) and Pay Item schedule (TS Section 1032.4.2)         aint in public area (paid and unpaid) since all wall		
16.	2010(1) Evacuation Passage, Handrail and Step	Civil F specifi Work.	pay item the same as the Emergency Stairs on the Plan Station Drawings? If so, please clarify the cations since the this pay item is under 2010 Steel May we also request for the detailed drawing for acuation passage mentioned.	The H	nes are stone finishes Pay item 2010(1) is for Evacuation Passage on CN-CE- 015 and other relevant drawings. Not for Emergency s.		
17.	Bill of Quantities pay item 1113(2a)	Please	provide details for Capacitor Banks and External y System.	& 01	Capacitor Bank Electrical schematic drawing (OS-2001 N-2001) needs to be referred. For UPS system 2 hrs ery Back backup has been considered.		

	Metro Manila Subway Project Phase 1 PACKAGE CP104: (ORTIGAS NORTH AND ORTIGAS SOUTH)						
ITEN NO.	A REFERENCE/CLAUSE/SEC	CTION	QUERIES	RESPONSE			
18.	Bill of Quantities, Bill 2A and	Please	provide existing Plans, details and relocation lay-out	Location and details shall comply with relevant authorities'			
	Bill 2B, Item No. 2005	for the	se items to be reinstated/relocated (Single Arm Street	requirements.			
		Lighti	ng)				
19.	Bill of Quantities, Bill 4A and	As per	Bill of Quantities, Alarm Reset Button and Alarm	Alarm Reset Button and Alarm Pull chord were removed.			
	Bill 4B, Item No. 1002	Pull C	hord (2 Bangles) are reflected but there are no plans	The items were deleted in Revised BOQ.			
		and sp	pecifications. Please clarify if this is part of scope. If				
		yes, pl	ease provide location on plans and its specifications.				
20.	BILL NO. 4a & 4b	May w	ve request a separate drawing details (Size, profile,	It is considered in BOQ with Pay Item no. 1804 (1) under			
		and co	nfigurations) for the item "Extruded Aluminum	Metal Louvers and located entrances and outdoor			
	Metal Louvers	Vertic	al Louvers".	machinery.			
				Please refer to Drawing Sheet No. STA-AR-A-ON/OS-9240			
	Pay Item no. 1804 (1)			(Typical Details); ON:STN-AR-A-ON-6033 to STN-AR-A-			
	Extruded Aluminum Vertical			ON-6047 & OS: STN-AR-A-OS-6007 to STN-AR-A-OS-6019			
	Louvers						
21.	BILL NO. 4a & 4b	May w	ve request a separate drawing details (Size, profile,	It is considered in BOQ with Pay Item no. 1804 (2) located			
		and co	nfigurations) for the item "Extruded Aluminum	at elevator shaft.			
	Metal Louvers	Horizo	ontal Louvers with Insect Screen".	Please refer to Drawing Sheet No. STA-AR-A-ON/OS-9131			

	Metro Manila Subway Project Phase 1 PACKAGE CP104: (ORTIGAS NORTH AND ORTIGAS SOUTH)					
ITEN NO.		TION QUERIE	S RESPONSE			
	Pay Item no. 1804 (1) Extruded Aluminum Horizontal Louvers with Insect Screen		(Typical Details); ON: STN-AR-A-ON-7000;STN-AR-A-ON 7001 & OS: STN-AR-A-OS-7000; STN-AR-A-OS-7001			
22.	BILL NO. 4a & 4b Metal Louvers	May we request a separate drawing det and configurations) for the item "Extrac Louver with Insect Screen" .				
	Pay Item no. 1804 (1) Extract Air Aluminum Louver with Insect Screen		5102; STN-AR-A-ON-5106 & OS: STN-AR-A-OS-5100 STN-AR-A-OS-5102; STN-AR-A-OS-5106			

	Metro Manila Subway Project Phase 1 PACKAGE CP104: (ORTIGAS NORTH AND ORTIGAS SOUTH)						
ITEN NO.	A REFERENCE/CLAUSE/SE	CTION	QUERIES	RESPONSE			
				Image: Sector			
23.	BILL NO. 4a & 4b	May w	e request a finishing Schedule, Locations and	Please refer to drawing sheet no. STA-AR-A- ON/OS-9060			
		Drawi	ngs details for the item "Aluminum Composite Panel	"Detail-C".			
	Ceiling Works	Claddi	ng ".	Aluminum panels are used only at entrance locations.			
	Pay Item no. 1811 (9) Aluminum Composite Panel Cladding			A DETERT - C			

	Metro Manila Subway Project Phase 1 PACKAGE CP104: (ORTIGAS NORTH AND ORTIGAS SOUTH)							
ITEN NO.	A REFERENCE/CLAUSE/SE	CTION	QUERIES	RESPONSE				
24.	BILL NO. 4a & 4b	As sta	ted on the provided Technical Specifications (File	12mm thk for toilet partition while 18mm thk is used for				
		Page:6	671 / PDF Page:687):	operable wall partitions. Please see drawing sheet no. STA-				
	Phenolic Partitions			AR-A-OS/ON-9501.				
	Pay Item no. 1816 (1) a3	Desc	ription: 12 mm thick high pressure-laminate (HPL) 18					
	1816 (1) a1	mm th	ick phenolic board toilet/urinal partition and toilet	Please refer to BOQ Pay Item No. 1816 (1) a1, 1816 (1) a2				
	1816 (1) a2	door, f	loor-mounted,including hinged doors, front pilasters,	and 1816 (1) a3.				
	Phenolic Partition - Shower	pedest	als including accessories to complete the assembly					
	Partition and fix		king to building structure.					
	Phenolic Partition - Toilet							
	Partition	We we	ould like to clarify that the Phenolic Board is 18mm					
	Phenolic Partition - Urinal	THK a	and the High Pressure-Laminate is 12mm THK which					
	Partition	means	12mm HPL + 18mm Phenolic board + 12mm HPL is					
		the co	mplete set of finish $(12 + 18 + 12 = 42 \text{mm thk})$ for the					
		partito	ons.					
		Please	Clarify.					
25.	BILL NO. 4a & 4b	May w	ve request a Fire Rated Rooms Schedule indicating	Fire rated construction for rooms are indicated in drawing,				
	Room Fire Rating hours	requir	ed fire rating hours.	please see drawing sheet no. STA-AR-A-OS/ON-0600/0601.				
	Intumescent Painting			Intumescent coating is only used for steel structural				
				members of glass shaft elevator from B1F to B3F.				

Annez	Metro Manila Subway Project Phase 1 PACKAGE CP104: (ORTIGAS NORTH AND ORTIGAS SOUTH)							
ITEN NO	REFERENCE/CLAUSE/SECTION		QUERIES	RESPONSE				
26.	3. CP104 BOQ       As point table_10Dec2020_Bill.No.2,3,         4,5 / Bill 5 A / 1126       Telep         (7),1126(8),       Bid I         confi       confi		Technical Specifications, Main Distribution Frame (MDF) and Distribution Frames (IDF) are by none service provider. However, it is still reflected in alletin No.5, Revised Bill of Quantities. Kindly in if we will still provide cost for these items. If yes, we like to request for the technical specifications	<ul> <li>1127.2.4 "MDF Room" should be corrected as "Telecom Room".</li> <li>The scope of the telephone service provider should be clearly shown in the relevant drawings. Demarcation NOTE in MEP drawings shall be modified.</li> <li>Kindly refer to updated BOQ. TEL and LAN system only includes cable trays and conduits.</li> </ul>				
27.	Specifications, Section 1126           27. CP104 BOQ         As p           table_10Dec2020_Bill.No.2,3,         plate           4,5 / Bill 5 A / 1126         device           (6a) ,1126(6b) ,         Bulle		r Technical Specifications, telephone jacks and face are by Telephone service provider. However, field s such as telephone outlets are still reflected in Bid in No.5, Revised Bill of Quantities. Kindly confirm if l still provide cost for these items. If yes, we would like test for the technical specifications	The scope of the telephone service provider should be clearly shown in the relevant drawings. Demarcation NOTE in MEP drawings shall be modified. These are excluded in the updated BOQ.				

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ITEN NO.		CTION	QUERIES	RESPONSE
	MEP Technical Specifications, Section 1126			
28.	CP104 BOQ table_10Dec2020_Bill.No.2,3, 4,5 / Bill 5 A / 1127 (6)	test ar softwa	Technical Specifications, "Design, supply, install, ad commission of all equipment (hardware and re), cables, materials and interfaces required to ete the Local Area Network System (LAN System) are	The scope of the telephone service provider should be clearly shown in the relevant drawings. Demarcation NOTE in MEP drawings shall be modified.
	CP104 BOQ table_10Dec2020_Bill.No.2,3, 4,5 / Bill 5 B / 1127 (6) MEP Technical Specifications, Section 1127	Bullet as LAI still pr	ephone service provider". However, as per Bid in No.5, Revised Bill of Quantities, field devices such N outlet are still reflected. Kindly confirm if we will rovide cost for these items. If yes, we would like to at for the technical specifications	Kindly refer to updated BOQ. TEL and LAN system only includes cable trays and conduits.
29.		test ar softwa comple by Tel Bullet Distril	Technical Specifications, "Design, supply, install, ad commission of all equipment (hardware and re), cables, materials and interfaces required to ete the Local Area Network System (LAN System) are ephone service provider". However, as per Bid in No.5, Revised Bill of Quantities, Intermediate pution Frame (IDF) are still reflected. Kindly confirm will still provide cost for these items. If yes, we would	The scope of the telephone service provider should be clearly shown in the relevant drawings. Demarcation NOTE in MEP drawings shall be modified. Kindly refer to updated BOQ. TEL and LAN system only includes cable trays and conduits.

Annex	Metro Manila Subway Project Phase 1 PACKAGE CP104: (ORTIGAS NORTH AND ORTIGAS SOUTH)						
ITEN NO.		CTION	QUERIES	RESPONSE			
	MEP Technical	like to	request for the technical specifications				
	Specifications, Section 1127						
30.	CP104 BOQ	As per	Technical Specifications, "Master Antenna Television	The scope of the telephone service provider should be			
	table_10Dec2020_Bill.No.2,3,	Syster	n are by Telephone service provider". However, as per	clearly shown in the relevant drawings. Demarcation			
	4,5 / Bill 5 A / 1125 (1-7)	Bid Bu	alletin No.5, Revised Bill of Quantities, Pay Item	NOTE in MEP drawings shall be modified.			
		1125,	there are line items dedicated for MATV System such				
	CP104 BOQ	as Cal	le Ladders, riser cables, conduits, field devices such	Kindly refer to updated BOQ. MATV is already excluded.			
	table_10Dec2020_Bill.No.2,3,	as TV	Outlets, MATV Head End Equipment and Pullbox.				
	4,5 / Bill 5 B / 1125 (1-7)	Kindly	v confirm if we will still provide cost for these items. If				
		yes, w	e would like to request for the technical specifications				
	MEP Technical						
	Specifications, Section 1125						
31.	CP104 BOQ	Please	provide reference plans for the new line item in	BOQ based the pay item on the following drawing STN-			
	table_10Dec2020_Bill.No.2,3,	Revise	ed BOQ at Bid Bulletin No.5, "Tunnel Fireman's	MEP-FPS-TUN8-3111; 3112; 2101			
	4,5 / Bill 5 A / 1123 (7)	Teleph	none including necessary controls, conduits and				
		wiring	s as required".				
	CP104 BOQ						
	table_10Dec2020_Bill.No.2,3,						
	4,5 / Bill 5 B / 1123 (7)						
32.	Bill of Quantities Bill 5A,	Please	clarify which type of fire extinguishers will be used	BOQ in GBB10 followed latest plans and Fire Extinguisher			
	Bill of Quantities Bill 5B,	since t	here are conflict between the Original BOQ, Revised	schedule			

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ITEN NO.	A REFERENCE/CLAUSE/SEC	QUERIES	RESPONSE
	STN-MEP-FPS-CWD-0102	BOQ, and Plans.	Portable fire extinguisher, including supporting frames or brackets and all other necessary accessories         pc         88.00           1202         1202(9)         FEX - Dry Chemical type, ABC class, 4.54kg         pc         88.00           1202         1202(7)         FEX - CO2 type, 4.54kg         pc         21.00           1202         1202(8)         WFEX - Foan Wheeled, ABC class, 22.68kg         pc         1.00
		Pay Item         Original BOQ         Revised BOQ         As Per Plan	1202 1202(7) WFEX - CO2 type, 22.68kg pc 1.00
		1202(8) FEX - Clean gas type, 4.54kg FEX - CO2 type, 4.54kg FEX - Clean Gas Type, 4.54kg	Portable fire extinguisher; including supporting frames or brackets and all other necessary accessories
		1202(6) WFEX - ABC class, 22.68kg WFEX - Dry chemical type, ABC class, 22.68kg WFEX - Foam Type, 22.68kg	1202         1202(9)         FEX - Dry Chemical type, ABC class, 4.54kg         pc         79.00           1202         1202(8)         FEX - Clean Gas type, 4.54kg         pc         17.00           1202         1202(9)         WFEX - Dry chemical type, ABC class, 22.68kg         pc         1.00           1202         1202(8)         WFEX - Clean Gas type, 22.68kg         pc         1.00
		1202(8)     WFEX - Clean gas type, 22.68kg     WFEX - CO2 type, 22.68kg     WFEX - Clean Gas Type, 22.68kg	
33.	CP104 BOQ	Kindly clarify if whose scope is the supply and installation of	f BOQ followed the Tech Specs showing "By Civil Contractor"
	table_10Dec2020_Bill.No.2,3,	400mm2 Copper Strip Grounding Mat. As per Specs	,
	4,5 / Bill 5 A / 1122 (2)	Schematic Diagram and Electrical Revised BOQ (Bid	1
		Bulletin No.5), it is by Civil Scope. However, it is not reflected	1
		on Civil Structural and Architectural Pay Item/BOQ.	
		Description Tech Specs Plans Electrical BOQ Civil BOQ	
		400mm2 Copper Strip By Civil Contractor Not reflected By Civil Contractor Not reflected	
34.	CP104 BOQ	As per Original BOQ, there is a separate Bill for Tunnel	5A/5B BOQ excluded Tunnel Lighting System based on the
	table_10Dec2020_Bill.No.2,3,	Lighting System (Bill 8). However, in Revised BOQ (Bid	scope of works
	4,5 / Bill 5 A / 1121 (a) / Bill	Bulletin No.5), there is a new line item for Tunnel Lightings	3
	5B / 1121 (a)	and outlets reflected in Bill 5A and Bill 5B. Kindly confirm	
	01_CP104_P1_S(IA)_(BF-	if both items are the same. If yes, please verify if we will	
	BOQ)_16Sep2020_rev / Bill 8	still consider the Bill 8 (Tunnel Lighting System).	
35.	STN-MEP-ELL-ON-2012	As per BOQ, Lighting fixtures for A1, A5 and B1 has no	DB schedule and Dialux report need to be referred for
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	Metro Manila Subway Project Phase 1 PACKAGE CP104: (ORTIGAS NORTH AND ORTIGAS SOUTH)						
ITEM REFERENCE/CLAUSE/SECTION QUERIES				RESPONSE			
	CP104 BOQ	P104 BOQ wattage ratings. But as per plan, each type of lighting		quantity and wattage of fixture.			
	table_10Dec2020_Bill.No.2,3,	fixture	has a designated wattage ratings, e.g. Type A1 has a				
	4,5 / Bill 5 A / 1118 (a) / 1118	wattag	e rating of 53 Watts and 34 Watts, which has				
	(b) / 1118 (li) / 1118 (lk) /	differe	nt cost. Kindly advise which wattage will be				
	1118 (ll) / 1118 (lm)	consid	ered in the cost.				

	Volume III Part 2 : Works Requirements Section VI Works Requirements General Specifications (GS)					
36.	GS 189	Please provide the requirements of the timing and	Deleted Appendix 2 _9.4 a) vii) FIT (Final Integration Test)			
	Appendix 1	duration of the Operation and Maintenance Period.				
	9.4 a) vii)					
	Final Integration Test					
	FIT shall be carried out at the end					
	of Operation and Maintenance					
	period. The Contractor shall					
	perform full system diagnostics test					
	to demonstrate that the system is					
	fully functional and have been					
	properly maintained.					

Annex	Metro Manila Subway Project Phase 1 PACKAGE CP104: (ORTIGAS NORTH AND ORTIGAS SOUTH)				
ITEM NO.	REFERENCE/CLAUSE/SECTION	QUERIES	RESPONSE		
		Volume III Part 2 : Works Requirements Section VI Works RequirementsTechnical Specifica			
		1 Civil			
37. V	Vol. II, Part 2: Works Requirements/	Pages BOQ-208 and BOQ-211:	These are clerical errors only.		
7	Technical Specifications (TS), 1: Civil				
۲	Works (General)	1) There are Pay Items 301(1) with incorrect item			
ŗ	p. 53 p. 86	description, and with quantities while it is			
ę	301-	indicated "not used" in technical specification.			
I	Bituminous Prime Coat	2) There are Pay Items description of "PCC			
I	Basis of Payment	Pavement (Unreinforced)" but Item Nos. are			
~~	'Not Used."	incorrect.			
		Are these clerical errors only? Please clarify.			
I	Bill of Quantities (BOQ) a part of				
S	Section IV, Bidding Forms				
ŗ	p. BOQ-208 & 211				
I	Part D: Building Works/ D.1				
S	Structural Works				
I	Item 310(1)-				
I	PCC Pavement (Unreinforced), m <sup>3</sup>				
38. V	Vol. II, Part 2: Works	Pages BOQ-208 and BOQ-211:	These are clerical errors only.		

Annex	Metro Manila Subway Project Phase 1 PACKAGE CP104: (ORTIGAS NORTH AND ORTIGAS SOUTH)				
ITEM NO.	REFERENCE/CLAUSE/SECTION	QUERIES	RESPONSE		
	Requirements/Technical				
	Specifications (TS), 1: Civil Works	There are Pay Items 400(1), 400(2), 400(5), 400(6),			
	(General)	405(2), 402(1&2), 405(1), and 414 but Part 4- Bridge			
	p. 90 Part 4	Construction is indicated "not used" in technical			
	BRIDGE CONSTRUCTION	specification.			
	Not Used."				
		Please clarify.			
	Bill of Quantities (BOQ) a part of				
	Section IV, Bidding Forms				
	p. BOQ-208 & 211				
	Part D: Building Works				
	D.1 Structural Works				
30	BOQ	Please provide the drawings describing the scope of	Please refer to drawing sheet no. STA-AR-A- ON-9060		
	BOQ Bill No. 4A & 4B	the Aluminum Composite Panel Cladding.	"Detail-C".		
		the Alumnum Composite Faner Clauding.			
	1811		Aluminum panels are used only at entrance locations.		
	Aluminum Composite Panel				
	Cladding		Refer to TS Section 18112.1.3 and Pay Item 1811 (3)		

-iiiiex	Metro Manila Subway Project Phase 1 PACKAGE CP104: (ORTIGAS NORTH AND ORTIGAS SOUTH)				
ITEM NO.	REFERENCE/CLAUSE/SECTION	QUERIES	RESPONSE		
	No drawings describing scope of the paint finish are found in both the North and South Stations.				
	BOQ Bill No. 4A, 4B 1811 & Bill No. 7A 1039 Aluminum Composite Panel Cladding at the Stations and Pedestrian Bridge There are no specifications for the Aluminum Composite Panel Cladding found.	Please provide the specifications for the Aluminum Composite Panel Cladding.	Bill No. 4A, 4B 1811Refer to drawing sheet STN-AR-A-OS-9180, Detail Aregarding Aluminum Coping describe in TS Section1039.2.1 with Pay Item 1039Refer to drawing sheet STA-AR-A- ON-9060, Detail-Cregarding Aluminum Ceiling Panel describe in TS Section18112.1.3 with Pay Item 1811 (3)		
41.	TS2 Arch p604 to p606 1811.2.1 Armstrong Aluminum Ceiling Panels <sup>:</sup> CLG-1, CLG-2, CLG-3, CLG-6, CLG- 7 Manufacturer <sup>:</sup> Armstrong or approved equal or better.	We are unable to contact the manufacturer: Armstrong since their website show "Armstrong World Industries, Inc. has completed the sale of its EMEA and Pacific Rim businesses." Kindly provide us the contact and email address which are very reliable because these ceilings are very complicated due to ceiling depths as well as earthquake zone, and therefore probably be extremely expensive.	Material can be acquired/referenced to other suppliers that has similar or better specifications as indicated. Just for only Bidder's reference, below is the contact of Armstrong ceiling solutions brought by Knauf. Anthony B. Vargas, Country Manager Philippines. Email: <u>Vargas.Anthony@knaufmarketing.com</u>		

	Metro Manila Subway Project Phase 1 PACKAGE CP104: (ORTIGAS NORTH AND ORTIGAS SOUTH)				
ITEM NO.	REFERENCE/CLAUSE/SECTION	QUERIES	RESPONSE		
42.	TS2 Arch p296 to p299	The requirements are proprietary specifications.	Granite stone can be referred to other suppliers that has		
	1018.6.1	Therefore there will be no competitiveness in prices.	equal or better materials specifications matching the		
	Granite Stones: FLG-01, FLG-01,	Please specify other granite stones which the	stones indicated.		
	FLG-02, FLG-03, FLG-04, GTL-01,	bidders are able to select from a list of approved	Bidders can select/nominate different supplier/		
	GTL-02, GTL-03, GTL-04, GTL-05,	manufacturers in order to make prices competitive	Manufacturer as long as the size and color of granite stone		
	SKT-01, In-laid Granite Stone	and to avoid increase of the project cost.	match the specifications. "Approved equal or better" is		
	Directional Symbol with Metal Trim,		indicated in the stone specifications to avoid reference to		
	Granite Stone Threshold		single supplier/Manufacturer.		
	Manufacturer: Kaufmanstone or				
	approved equal or better.		Possible other comparative suppliers are "Euroasia" and		
			"MultiRich" for your selection of competitive price. Just for		
			Bidderr's/ contractor's reference only.		
		2 Architecture			
43.	Vol. II, Part 2: Works	Pages BOQ-208 and BOQ-211:	Item 802 (1) Unsuitable soil not applicable.		
	Requirements/Technical				
	Specifications (TS), 2: Architecture	There is Item 802 (1) with item description of "Fill	Pay Item 802(1) tagged as "Not Used "on TS in GBB 10		
	p. 54	and Backfill", and with quantities while in the			
	Part 8:	Technical Specification, Item 802 (1) is Unsuitable			
	Earthwork	Excavation.			
	Item 802	Please clarify.			

	Metro Manila Subway Project Phase 1 PACKAGE CP104: (ORTIGAS NORTH AND ORTIGAS SOUTH)				
ITEM NO.	<b>1</b> REFERENCE/CLAUSE/SECTION	QUERIES	RESPONSE		
	Excavation				
	Item 802(1)-				
	Unsuitable Excavation in Cubic				
	Meter				
	Bill of Quantities (BOQ) a part of				
	Section IV, Bidding Forms				
	p. BOQ-208 & 211				
	Part A: Earthworks				
44.	Arch	Please advise us how many group masters keys and	Minimum of 4 master keys for each group, and 4 keys for		
	P175	grand master keys you require.	grand master keys		
	1004.2.4 12)				
	VI				
	DWG				
	Arch				
	Master Keys				
	DWG Nos. STN-AR-A-ON/OS-7007				
	to7011				
	The second last note in the drawings				
	indicate "CONTRACTOR SHALL				

Annex	Metro Manila Subway Project Phase 1 PACKAGE CP104: (ORTIGAS NORTH AND ORTIGAS SOUTH)				
ITEM NO.	REFERENCE/CLAUSE/SECTION	QUERIES	RESPONSE		
	PROVIDE 10 COPIES OF MASTER				
	KEYS".				
	However Item 12) of the				
	specifications state the followings:				
	"In general, provide for grand master				
	keying. Provide at least 4 keys for				
	each lock, 4 master keys for each				
	group of locks, and 4 grand master				
	keys, unless otherwise requested by				
	the Employer."				
45.	TS2 Arch p176 & p181	Despite of the statement in the specifications, there	Thresholds provided are similar to the floor finish where		
	1004.2.4 17)	are no aluminum thresholds with the sealant in Bill	the door is located. Refer to Pay item:		
	1004.3.3 11)	No. 4. Kindly provide the pay items and quantities.			
			1018 (5) b9 Glazed Ceramic Tile – 200mm Threshold		
	BOQ		1018 (3) a3 Granite Stone Honed Finish – 200mm		
	Bill No. 4		Threshold		
	Aluminum Thresholds with Sealant		1020 (3) Vinyl Tile – 200mm Threshold		
	The specifications state the		BOQ References:		
	followings:		OSS		
	"In accordance with BHMA A156.21;		1018 (5) b9 Glazed Ceramic Tile – 200mm Threshold		

	Metro Manila Subway Project Phase 1 PACKAGE CP104: (ORTIGAS NORTH AND ORTIGAS SOUTH)					
ITEM NO.	REFERENCE/CLAUSE/SECTION	QUERIES	RESPONSE			
in a d l e s h "" e in h t t in s	abricated to full width of opening ndicated. Thresholds shall be in luminum at exterior and interior loors and installed complete with ead shields using stainless steel crews, except washroom doors to have stone thresholds." and Thresholds: Set thresholds for xterior doors, and other doors indicated within the approved door hardware schedule and indicated on he Drawings, in full bed of sealant in accordance with requirements pecified in TS Section 1815 Sealants."		1018       1018 (5) b9       Gazed Ceranic Tile - 200mm Threshold       In       19.95         1018 (3) a3 Granite Stone Honed Finish – 200mm Threshold       In       19.95         1018 (3) a3 Granite Stone Honed Finish – 200mm Threshold       In       11.58         0NS       1018 (5) b9 Glazed Ceramic Tile - 200mm Threshold       In       11.58         0NS       1018 (5) b9 Glazed Ceramic Tile - 200mm Threshold       In       11.58         0NS       1018 (5) b9 Glazed Ceramic Tile - 200mm Threshold       In       24.80         1018 (3) a3 Granite Stone Honed Finish - 200mm Threshold       In       24.80         1018 (3) a3 Granite Stone Honed Finish - 200mm Threshold       In       24.80         1018 (1018 (3) a3 Granite Stone Honed Finish - 200mm Threshold       In       24.80			
1 C	7] 'S2 Arch p291 & p302 018.5, 2), 1018.5.2, 2) & 1018.6.2, 2) Granite Wall Tile - Dry Cladding The headings for sub-clauses 1018.5,	Please confirm which heading is correct.	Follow plans regarding granite tile installation methodology. BOQ considered dry cladding.			

	Metro Manila Subway Project Phase 1 PACKAGE CP104: (ORTIGAS NORTH AND ORTIGAS SOUTH)				
ITEM NO.	REFERENCE/CLAUSE/SECTION	QUERIES	RESPONSE		
S	2) and 1018.5.2, 2) are Granite Wall File -Dry Cladding. On the other hand, the heading for sub-clause 1018.6, 2) is Granite Wall Tile - Wet Cladding		Addendum for TS: Update specifications for 1018.6.2.2 to Granite Wall Tile- Dry Cladding		
47.	FS2 Arch p346 & p381 DWG	May we consider that the cement plaster finish under painting shall be included in pay items 1027(1) Cement Plaster Finish in Bill No. 4?	We consider in BOQ under separate pay item no. 1027 (1) Cement plaster finish. BOQ References:		
] : : : : : : : : : : : : : : : : : : :	BOQ Bill No. 1027( 1032 1027.2.1 1032.2.1 Smooth Plaster Cement Finish under Painting Finishes Neither the sub-clauses 1027.2.1 nor 1032.2.1 of the specifications include		ONS         1027 (1) Cement plaster finish         1027       1027(1)         Cement Plaster Finish       m2         OSS         1027 (1) Cement plaster finish         1027 (1) Cement plaster finish         1027 (1) Cement Plaster finish         1027 (1) Cement Plaster finish		
1	the cement plaster finish under the painting.				

nnex "	'A"			

### Metro Manila Subway Project Phase 1 PACKAGE CP104: (ORTIGAS NORTH AND ORTIGAS SOUTH)

ITEM NO.	[ REFERENCE/CLAUSE/SECTION	QUERIES	RESPONSE
	DWG Nos. STN-AR-A-ON/OS-9002		
	indicate 20mm thick plaster under		
	PLT-02 Acrylic Polyurethane Paint		
48.	TS 02 Arch	We find these mock-up requirements are	Bidder should provide cost for the Mockup requirements
	P26 to P34	unreasonable and excessively expensive for the	specified in the Bidding documents. Size of the mockups
	P732 to P747	Employer. We request that you either remove these	shall be based on the drawing details
	C01.3 and	mock-up requirements since each section of the	
	Appendix 2	architecture specification describes mock-up	
	Mock-up Requirements	requirement required for the section, or that you	
	We have compiled the mock-up	please revise the requirements to the reasonable	
	requirements into 3D models in the	sizes and items.	
	attachment No. 1 and a facility	Please see Attachments to this RFC Set No 14	
	which will house the mock-ups	relating to this RFC.	
	required as per the specifications. It		
	shows that CP 104 contractor will		
	require a three story facility		
	approximately 60m long x 30m wide		
	x 16 high. Some requirements are as		
	follows:		
	1) Mock-up 2: Mock-up for Ortigas		
	South Entrance require visual mock-		

Metro Manila Subway Project Phase 1 PACKAGE CP104: (ORTIGAS NORTH AND ORTIGAS SOUTH)					
ITEM NO.	REFERENCE/CLAUSE/SECTION	QUERIES	RESPONSE		
u	p which shall have width and				
10	ength equal to the actual entrance				
b	uilding with the structural frames,				
а	set of roof and ceiling, a set of rain				
g	utter and downspout, security				
s	hutter, stair, handrail, signage,				
s	tone walls, floor finishing, flood				
b	arrier, railings, handrails, lightning				
а	rresters and lighting fittings as				
а	ssembled.				
2	) Mock-up 4: Mock-up for Ortigas				
S	bouth Escalator at B1F Level				
i	ncluding columns, walls, floors,				
g	allery walls, ceiling, doors, shutters,				
t	actile, balustrade, glass partition,				
s	moke curtain, supply and return air				
g	rills, and other required mechanical				
a	nd electrical equipment, lighting				
f	ittings, signage, etc.				
3	) Mock-up 5 - Mock-up for Ortigas				
S	outh Escalator at B3F Level				

	Metro Manila Subway Project Phase 1 PACKAGE CP104: (ORTIGAS NORTH AND ORTIGAS SOUTH)					
ITEM NO.	REFERENCE/CLAUSE/SECTION	QUERIES	RESPONSE			
iı	ncluding columns, walls, floors,					
g	allery walls, ceiling, doors, shutters,					
ta	actile, balustrade, glass partition,					
s	moke curtain, supply and return air					
g	rills, and other required mechanical					
a	nd electrical equipment, lighting					
fi	ttings, signage, etc.					
4	) Mock-up 1 - Mock-up for Ortigas					
S	outh Toilet and Ticket Office; A					
fi	all-scale mock-up of a room of each					
te	oilet and ticket to contain all					
a	rchitectural elements and a set of					
n	nechanical and electrical fittings					
iı	ncluding, but not limited to, water					
c	loset, lavatory-booth, washbasin					
с	ounter, vanity mirror, faucet, and					
li	ghting fittings.					
5	) Ventilation Tower Louvers at					
E	ntrance 2 in Mock-up 2 - Mock-up					
fe	or Ortigas South Entrance - 1					
(	1) A full-scale mock-up of a set of					

ITEM NO.	REFERENCE/CLAUSE/SECTION	QUERIES	
		<b>QUERTES</b>	RESPONSE
]	ouvers		
	6) Signage fixture prepared for each		
(	of the elements of the signage works		
i	ncluding the under laying steel		
\$	structure, other architectural		
(	components, and mechanical and		
(	electrical components involved		
49.	VI TS2	We received the following comments from the	Please check with other suppliers as stated in specs
2	280	specified supplier:	'approved equal or better'
	1018.2.1 4)	1. Ruvido Grigio tile is ceramic tile.	
	CTL-01 Wall Tile	2. They do not recommend to use for the size $1200 \text{ x}$	
:	Size: 1200 x 600 x 10mm.	$600 \ge 10$ mm because the standard size of this tile is	
(	Color: Mozzaico Ruvido Grigio or as	$300 \ge 300 \ge 10$ mm. They doubt if the manufacturer	
:	approved equal or better.	would produce this size for Ruvido Grigio tile which	
		is ceramic tile that is not strong such as porcelain	
		tile. They cannot communicate with the	
		manufacturer due to Chinese New Year holidays as	
		of this writing.	
		Please allow us to use the size of 300 x 300 x 10mm,	
		or specify other tiles from porcelain tiles.	
		3. Mechanical, Electrical and Plumbing	

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Metro Manila Subway Project Phase 1 PACKAGE CP104: (ORTIGAS NORTH AND ORTIGAS SOUTH)					
ITEM NO.	REFERENCE/CLAUSE/SECTION	QUERIES	RESPONSE		
	Technical Specifications 3: Mechanical, Electrical, Plumbing: Section 1241.2.3	Please clarify the starter for the controller to be used if wye-delta closed transition or wye-delta open transition.	If it is inertial type of load, open transition type shall be used. If it is frictional type of load, then closed transition shall be used.		
N S I	Technical Specifications 3: Mechanical, Electrical, Plumbing: Sections 1121 Bill of Quantities, Bill 5A and Bill 5B, Item 1121 (a), 1121 (b), 1121 (c)	As per technical specifications, low voltage power cables shall be grade fire resistant type with low smoke and fume (LSF) and zero halogen and XLPE insulated. However, in the Bill of Quantities, low voltage power cables are XHHW. Kindly clarify which will prevail?	XLPE will prevail. BOQ followed schematic diagram. Please confirm what will govern. Kindly refer to below plans. MEP Drawings and BOQ were amended in GBB10 Insticuted sq.mm Cu. XLPE + Insticuted sq.mm Cu. XLPE CPC CABLE ID CNE-1.9		
			Important Construction       Important Construction         Important Constend C		

Annex "A"

	Metro Manila Subway Project Phase 1 PACKAGE CP104: (ORTIGAS NORTH AND ORTIGAS SOUTH)						
ITEN NO.		QUERIES	RESPONSE				
52.	Technical Specifications 3:	Please confirm if no duct smoke detectors are to be	Required Duct Smoke Detectors Near Supply & return air				
	Mechanical, Electrical, Plumbing:	considered. No duct smoke detector units were on	ducts of AHU's.				
	Sections 1123.3.3	FDAS or Mechanical Plans but mentioned in the	Refer to the latest MEP Drawings & BOQ				
		technical specifications.					

	Volume III Part 2 : Works Requirements Section VI Works Requirements Employer's Drawings (DRW)						
53.	Ortigas North Station STP-MEP-ELL-ON-3111 STN-MEP-ELL-ON-3115 STN-MEP-ELL-ON-3122 STN-MEP-ELL-ON-3124 STN-MEP-ELL-ON-3131 STN-MEP-ELL-ON-3134 Bill of Quantities Bill 5A, Item 1113 (1bd and lbe ) Ortigas South Station STN-MEP-ELL-OS-3111 STN-MEP-ELL-OS-3113 STN-MEP-ELL-OS-3114 STN-MEP-ELL-OS-3122	Please provide Lighting Control Panel Load Schedule for both Station.	LCP shall be consisting of relay to operate presence detector of lighting circuits fed from various lighting DBs. Please note there shall not be any different lighting circuit inside the LCP. Lighting DB schedules is included under Electrical drawings (OS-2007 to 2052 and ON-2007 to 2046). Bidder also needs to refer to the latest BOQ Lighting ControlPanel(LCP); including Busbar, Neutral bus, selector switch, contactors, relays, integral surge protection devices (SPD), phase indicating lights, power meters and auxilliary contacts for BMS interconnection and all necessary accessories in accordance with the manufacturer's instructions and as shown in drawings with reference STN-MEP-ELL-OS-3100 to 3244				


Annex "A"


<u>annex</u>	Metro Manila Subway Project Phase 1 PACKAGE CP104: (ORTIGAS NORTH AND ORTIGAS SOUTH)						
ITEM NO.	REFERENCE/CLAUSE/SECTIO	ON QUERIES	RESPONSE				
5	STN-MEP-ELL-OS-3124 STN-MEP-ELL-OS-3131 STN-MEP-ELL-OS-3134 Ortigas North StationSTP-MEP- ELL-ON-3111STN-MEP-ELL- ON-3211Ortigas South StationSTN-MEP-ELL-OS- 3114STN-MEP-ELL-OS-3214	Kindly provide details for this panel.	Outgoing distribution of Retail DB is unknown only 6 Way TPN DB has been considered.				
55. 5	STN-MEP-PLD-OS-3231	Kindly verify/provide drainage piping layout and sizes of floor drain located near the janitor space (Grid B-5) at Platform Level Ortigas South Station.	Pipe routing for platform level FD comes in Under- platform level, Under-platform level is under Civil scope which is stated in Drainage Layout & Schematic.				

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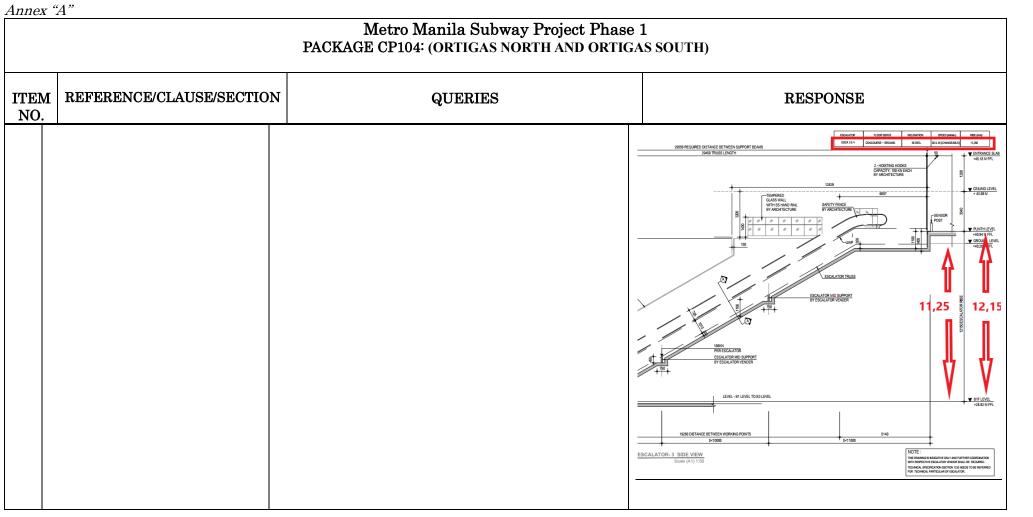
Annex	Metro Manila Subway Project Phase 1 PACKAGE CP104: (ORTIGAS NORTH AND ORTIGAS SOUTH)					
ITEM NO.	REFERENCE/CLAUSE/SECTIO	N QUERIES	RESPONSE			
		JANITOR SPACE				
56.	STN-MEP-PLD-OS-3233	Kindly verify/provide drainage piping layout and size of floor drain located at Ortigas South Station near Staircase 6 (Grid B-19) at Platform Level.	Pipe routing for platform level FD comes in Under-platform level, Under-platform level is under Civil scope which is stated in Drainage Layout & Schematic			
57.	STN-MEP-PLD-OS-3234	Kindly verify/provide drainage piping layout and size of floor drain located at Ortigas South Station near Access Hatch (Grid B-32) at Platform Level.	Pipe routing for platform level FD comes in Under- platform level, Under-platform level is under Civil scope which is stated in Drainage Layout & Schematic			

		Metro Manila Subway Project Pha PACKAGE CP104: (ORTIGAS NORTH AND ORTI			
ITEM NO.	1 REFERENCE/CLAUSE/SECT	ION QUERIES	RESPONSE		
		FD ACCES HATCH ABOVE			
58.	STN-MEP-PLD-OS-3221	Kindly provide/verify the drainage piping layout from the 300mm wide drain channel located at Ortigas South Station Mezzanine Level (Grid A-7)	There will be no piping to drain, water from 300mm wide drain channel. From 300mm drain channel it will goes to nearby FD directly		
59.	STN-MEP-PLD-ON-2201 STN-MEP-PLD-OS-2201	Kindly verify what type of scupper is shown. Also, provide detailed drawing.	Details of Scupper drain is in Arch. Scope, Refer STN-AR- A-ON-9180 for details		



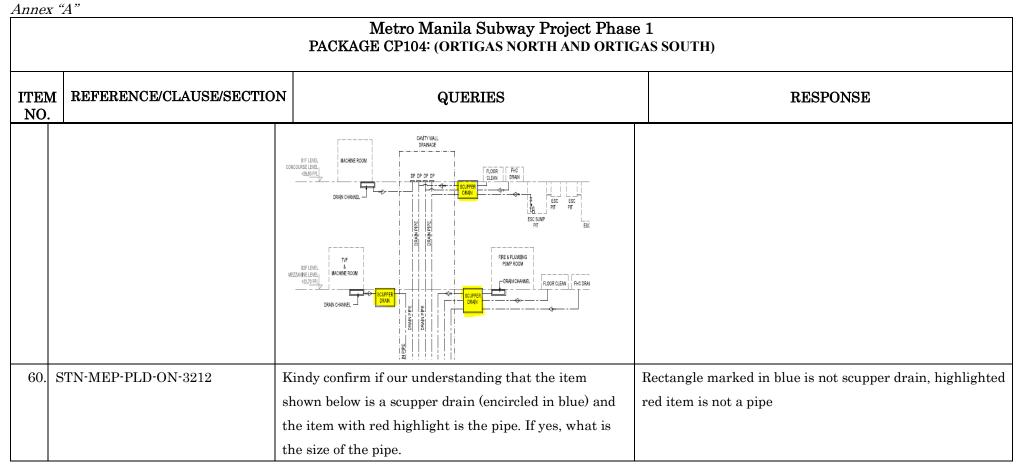

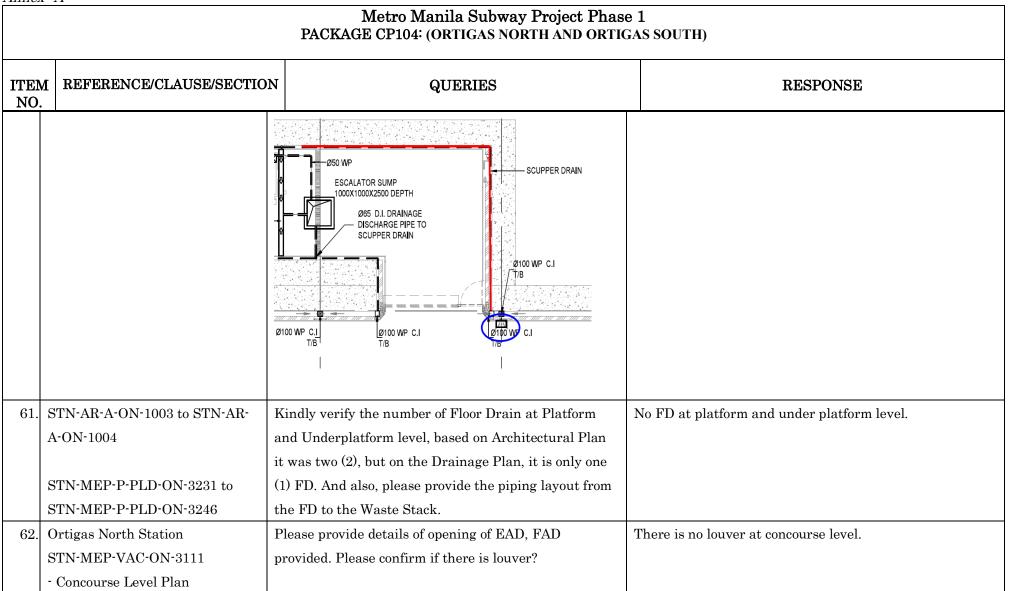	Metro Manila Subway Project Phase 1 PACKAGE CP104: (ORTIGAS NORTH AND ORTIGAS SOUTH)							
ITEM NO.	REFERENCE/CLAUSE/SECTION	QUERIES	RESPONSE					
		0 EAD DEAD DEAD DEAD DEAD DEAD DEAD PLENUM SIZE-4000 (2150 x 2000 (H) PLENUM SIZE-2200 x 140 0 x 2000 (H) D 3200 X 300 FADEAD MULTIPURPOSE						
63.		In reference to Escalator Rise, the plan lay-out shows 12.15meters of rise. However, in the same plan, the	Escalator rise shall be 12150 mm					
		escalator summary shows an escalator rise of	Bidder to refer to the information below, And bidder to					
		11.25meters. Which will prevail?	understand the drawing before making such query.					



Annex	"A	,
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	Metro Manila Subway Project Phase 1 PACKAGE CP104: (ORTIGAS NORTH AND ORTIGAS SOUTH)					
ITEN NO.	REFERENCE/CLAUSE/SECTIO	N QUERIES			RESPONSE	
64.	Bill of Quantities Bill 5B, Item 1233 (1) MEP-VAC-OS-3825, MEP-VAC- OS-3826, MEP-AR-A-OS-1001	prevail: Description South Station ESCA 2 Step width	y which of the fo As per MEP Plan 1010 mm	As per Architectural Plan 1000 mm	As per BOQ 1550 mm	NOTE:       This DRAWNG IS NOLCATIVE ONLY AND FURTHER COORDINATION WITH RESPECTIVE ESCALATOR VENDOR SHALL BE REQUIRED.         TECHNICAL SPECIFICATION SECTION 123 NEEDS TO BE REFERRED FOR TECHNICAL SPECIFICATION SECTION 123 NEEDS TO BE REFERRED FOR TECHNICAL PARTICULAR OF ESCALATOR.         METRO MANILA SUBWAY PROJECT       DATE         PHASE1       BALL E         PACKAGE CP 104       SHEET NA.         Ortigas South Station       STI-MEP-VAC-OS-3827         DRG No.       STI-MEP-VAC-OS-3827         DRG N.       STI-MEP-VAC-OS-3827         DRG N.       STI-MEP-VAC-OS-3827         DRG No.       STI-MEP-VAC-OS-3827
65.	Bill of Quantities Bill 5B, Item 1233 (1)	Please clarify prevail:	Please clarify which of the following conflict items shall prevail:			Escalator step width shall be minimum 1000 mm. However, BOQ description provides total width of

Annex "A"

Annex	Metro Manila Subway Project Phase 1 PACKAGE CP104: (ORTIGAS NORTH AND ORTIGAS SOUTH)							
ITEM NO.	REFERENCE/CLAUSE/SECTIO	N	QUERIES			RESPONSE		
	MEP-VAC-OS-3828, MEP-VAC-	Description	As per MEP Plan	As per Architectural Plan	As per BOQ	escalator requirements including housing. Please refer to the MEP Plan Drawing below		
	OS-3829, STN-AR-A-OS-1003	South Station ESCA 3 Step 1010 mm 1 width	1000 mm	1550 mm	METRO MANILA SUBWAY PROJECT August 2020 PHASE1 SCALE AS SHOWN			
					•	Ortigas South Station     Escalator No. 3 (Sheet 2)		
						NOTING         WOVING         WOVING <td c<="" th=""></td>		

	Metro Manila Subway Project Phase 1 PACKAGE CP104: (ORTIGAS NORTH AND ORTIGAS SOUTH)					
ITEM NO.	REFERENCE/CLAUSE/SECTION	QUERIES	RESPONSE			
		Page 47 of 60	NOTE : THIS DRAWING IS INDICATIVE ONLY AND FURTHER COORDINATION WITH RESPECTIVE ESCALATOR VENDOR SHALL BE REQUIRED. TECHNICAL SPECIFICATION SECTION 1233 NEEDS TO BE REFERRED FOR TECHNICAL PARTICULAR OF ESCALATOR. DURING CONSTRUCTION, ARCHITECTURE (STRUCTURE) CONTRACTOR NEED TO FURTHER COORDINATION WITH SELECTED ESCALATOR VENDOR FOR FIXING ARRANGEMENT OF MOUNTING PLATE.			


Annex	"A	,

		Metro Mani PACKAGE CP104: (OR		Project Phas TH AND ORTIC		
ITEM NO.					RESPONSI	6
1 M C	Bill of Quantities Bill 5B, Item 1233 (1) MEP-VAC-OS-3831, MEP-VAC- OS-3832, STN-AR-A-OS-1002, STN-AR-A-OS-1003	Please clarify which of the for prevail:         Description       As per MEP Plan         South Station         ESCA 4-5 Step         width	llowing confl As per Architectural Plan 1000 mm	ict items shall As per BOQ 1550 mm	METRO MANILA SUBWAY PROJECT PHASE1 PACKAGE CP 104 Ortigas South Station Escalator No. 3 (Sheet 3) Escalator step width shall be minim However, BOQ description provides escalator requirements including hor	total width of
1 S A	Bill of Quantities Bill 5B, Item 1233 (1)STN-MEP-VAC-OS-3834, STN-MEP-VAC-OS-3835, STN- AR-A-OS-1004 to STN-AR-A-OS- 1005	Please clarify which of the fo prevail:	llowing confl	ict items shall	Escalator step width shall be minim However, BOQ description provides escalator requirements including ho Please refer to the MEP Plan Drawin	total width of using.


	Metro Manila Subway Project Phase 1 PACKAGE CP104: (ORTIGAS NORTH AND ORTIGAS SOUTH)						
ITEM NO.	REFERENCE/CLAUSE/SECTION	ſ	QU	JERIES		RESPONSE	
NO.		Description South Station ESCA 6 - 9 Step width	As per MEP Plan	As per Architectural Plan	As per BOQ	Image: Note of the second s	
						WITH RESPECTIVE ESCALATOR VENDOR SHALL BE REQUIRED. TECHNICAL SPECIFICATION SECTION 1233 NEEDS TO BE REFERRED	

Annex	" $A$ "
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	Metro Manila Subway Project Phase 1 PACKAGE CP104: (ORTIGAS NORTH AND ORTIGAS SOUTH)						
ITEM NO.	REFERENCE/CLAUSE/SECTIO	N QUERIES	RESPONSE				
			METRO MANILA SUBWAY PROJECT PHASE1     DATE August 2020       PACKAGE CP 104     SCALE AS SHOWN       PACKAGE CP 104     SHEET No.       Ortigas South Station Escalator No. 6,7,8 & 9 (Sheet 3)     DRG No. STN-MEP-VAC-OS-3835				
68.	STN-CE-OS-0436	Based on the bid drawings provided. We noticed that there are no details of stirrups/ ties for Ventilation Shaft, also Slab and Wall reinforcement details of Entrance 01. May we request for the detailed drawings/blow-up reinforcement.	There are no detail for stirrups as the detail design still has not completed yet. For bidding pricing, please refer to the quantity of Steel bar in BOQ 2008(5) for each station.				

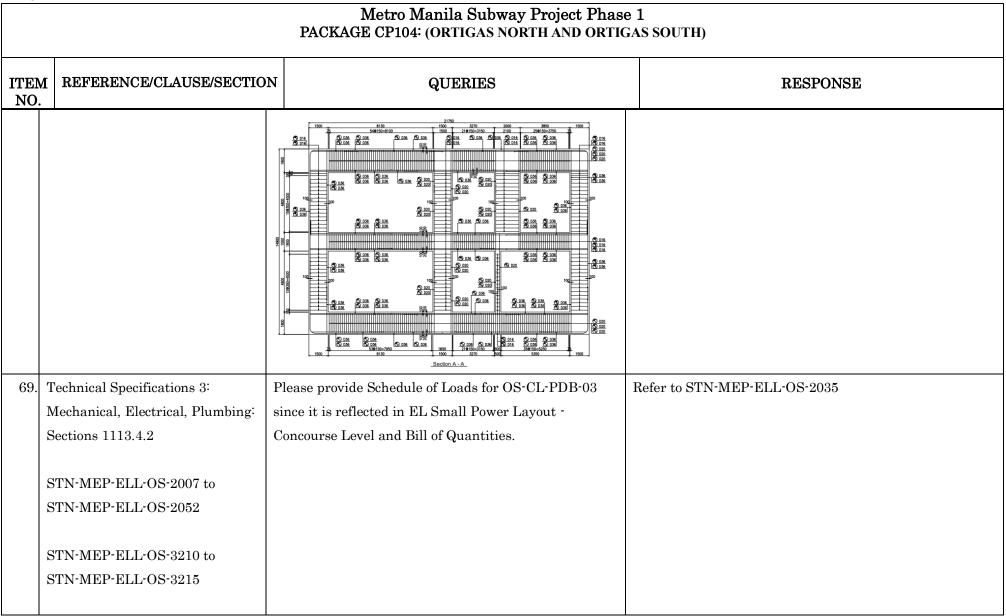

	Metro Manila Subway Project Phase 1 PACKAGE CP104: (ORTIGAS NORTH AND ORTIGAS SOUTH)							
ITEN NO.		N QUERIES	RESPONSE					
	Bill of Quantities 1113 5B, Item 1113							
70.	STN-MEP-ELL-CWD-1004	As per our understanding this figure 7.13 is a stand alone setup for occupancy sensor, while figure 7.03 is a digital system setup. Please provide the zones applicable for each setup. $\qquad \qquad $	There are two control points of lighting distribution of a level one at right side electrical room another one at left side. However, presence detector coverage 7m for small room 14m bigger room to switch on/off light fixtures.					
71.	STN-MEP-BMS-CWD-1013 STN-MEP-BMS-CWD-1014	Please provide sequence of operation for the Tunnel Ventilation Fan and Motorized Smoke and Fire Damper.	Tunnel Ventilation operation Conditions are shown in the Drawings: STN-MEP-BMS-OS-3761,3762,3763 & STN- MEP-BMS-ON-3771,3772,3773					
72.	STN-MEP-VAC-CWD-0104	In reference to the detail sheet for Air Handling Unit with mixing box, what is the abbreviation of MMCD?	MEP drawing was updated to show the Air Handling Unit with mixing box. Please refer to STN-MEP-VAC-CWD-1106-0.					

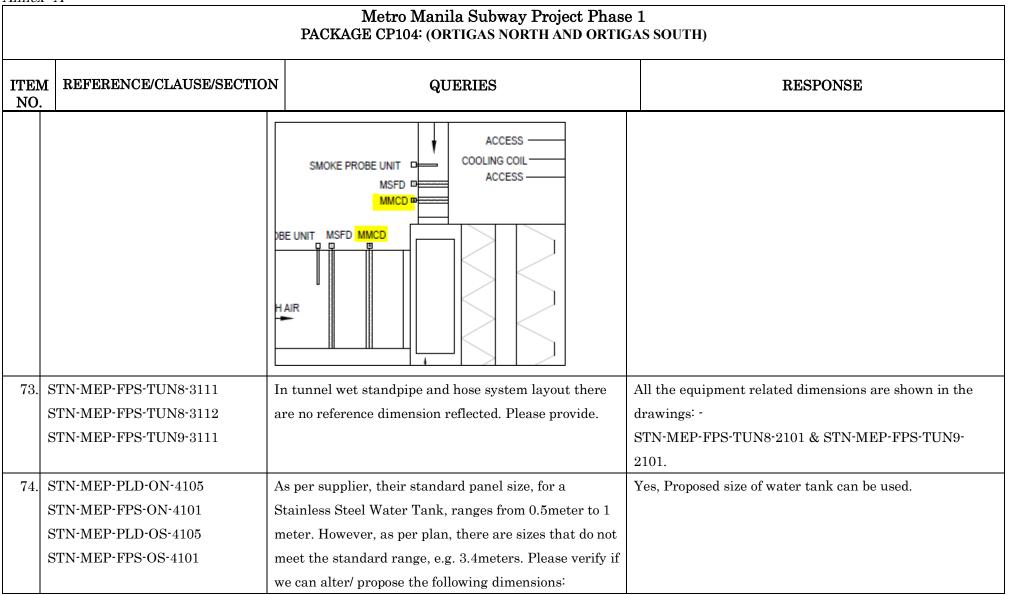


Annex "A"

			co Manila Subv 104: (ORTIGAS 1				
ITEM NO.	REFERENCE/CLAUSE/SECTION		QUERIES				RESPONSE
	1	Item Description	Original Dimension L(m) X W(m) x H(m)	Proposed Tar L(m) X W(			
		1 Domestic Water Tank 1 2 Domestic Water Tank 2 3 Make Up Water Tank 1	7m x 3m x 3.4m 7m x 3m x 3.4m 8m x 2.4m x 3.4m	7m x 3m 7m x 3m 8m x 2.5i	x 3.5m n x 3.5r	n	
		4 Make Up Water Tank 2 5 Sewage Tank 1 6 Sewage Tank 2 7 Fire Water Tank 1	8m x 2.4m x 3.4m 2m x 2m x 2m 2m x 2m x 2m 17.3m x 2.44m x 3.45m	8m x 2.5i 2m x 2i 2m x 2i 17m x 2.5	m x 2m m x 2m		
		8 Fire Water Tank 2 ORTIGAS SOUTH 1 Domestic Water Tank 1 2 Domestic Water Tank 2	e Water Tank 2 17.3m x 2.44m x 3.45m <b>S SOUTH</b> mestic Water Tank 1 7.24m x 3m x 3.4m		m x 3.5 x 3.5m x 3.5m		
		3 Make Up Water Tank 1 4 Make Up Water Tank 2 5 Sewage Tank 1	8m x 3m x 3.4m 6m x 4m x 3.4m 6m x 4m x 3.4m 2m x 2m x 2m	6m x 4m 6m x 4m 2m x 2	x 3.5m x 3.5m		
		6 Sewage Tank 2 7 Fire Water Tank 1 8 Fire Water Tank 2	2m x 2m x 2m 7.95m x 5.3m x 3.4m 12.58m x 3m x3.4m	2m x 2 8m x 5.5 12.5m x 3	m x 3.5r		
	-	In reference to Bid I quantity for Water I				e	BOQ updated following latest equipment schedule. Please see screenshot below.
		match the equipmen quantity will prevai		se clarify v	whicł	1	OSS - BOQ
		As per BOQ:					Water heater; complete with driving motor, all necessary accessories and connection, electrical/control wirings, conduits and complete as in the equipment schedule and as described
			ESCRIPTION		UNIT	QTY	1237(5)         Electric water heater; 25L capacity; horizontal wall mounted, 2kW; 3ph; 380V; 60Hz, ref SL no.1         2         pc           1237(5)         Electric water heater; 15L capacity; horizontal wall mounted, 1.5kW; 3ph; 380V; 60Hz, ref SL no.2 to 4         5         pc
		Electric water heater; 15L capaci 380V; 60Hz, ref SL no.2 to 4	ity; norizontai wali mouhted,	1.экw; зрп;	рс	5.00	OSS - Equipment Schedule

TEM NO.	REFERENCE/CLAUSE/SECTIO	N	QUERI	ΈS		-	RESPONSE			
		As per Equ	ipment Schedule:		SL. NO.	LOCATION	WATER HEATER NO.			
		SL. NO.	LOCATION	WATER HEATER NO.	1.	SECURITY STAFF SHOWER (M) & (F)	2			
		2.	FIRST AID ROOM	1	2.	FIRST AID ROOM	1			
		3,	STAFF TOILET (M)	1	3.	PUBLIC TOILET (M)	1			
					4.	PUBLIC TOILET (F)	1			
		4.	STAFF TOILET (F)	1	5.	STAFF TOILET (M)	1			
					6.	STAFF TOILET (F)	1			
					ONS -	BOQ	· · · · ·			
						Water heater; complete with and connection, electrical/c in the equipment schedule a	ontrol wirings, conduits ar			1
					1237(5)	Electric water heater; 25L 3ph; 380V; 60Hz, ref SL no	capacity; horizontal wall m	nounted, 2kW;	2	ро

	Metro Manila Subway Project Phase 1 PACKAGE CP104: (ORTIGAS NORTH AND ORTIGAS SOUTH)						
ITEM NO.	REFERENCE/CLAUSE/SECTIO	N QUERIES		R	ESPONSE		
			SL. NO.	LOCATION	WATER HEATER NO.	-	
			1.	SECURITY STAFF SHOWER (M) & (F)	2		
			2.	FIRST AID ROOM	1		
			3.	MULTIPURPOSE TOILET (M)	1		
			4.	MULTIPURPOSE TOILET (F)	1	-	
			5.	STAFF TOILET (M)	1		
			6.	STAFF TOILET (F)	1		
76.	STN-MEP-VAC-ON-3123 and	Please verify if there is a need for airconditioning	Railv	vay System is differen	t scope.		
	STN-MEP-VAC-ON-3124	ductworks and air terminals for the following Ceiling	Duct	work and Air termina	als details sha	all be updated "by	
		Concealed unit:	contr	actor" once system la	youts are ava	ailabe.	
		1.ON- MZ- IU- 2A/2B (2 UNITS)					
		2.ON-MZ- IU-8A/8B/8C/8D (4 UNITS)	Typic	al detail VAC-CWD	1104 should i	nclude the detail.	
		3.ON-MZ-IU-10A/10G (7 UNITS)	Lum	osum line items shall	be included	in the BOQ for the	
			tenta	tive ductwork inside	system room	s.	
		If yes, please provide detailed ducting layout with					
		specific Air terminal Grille Size.					

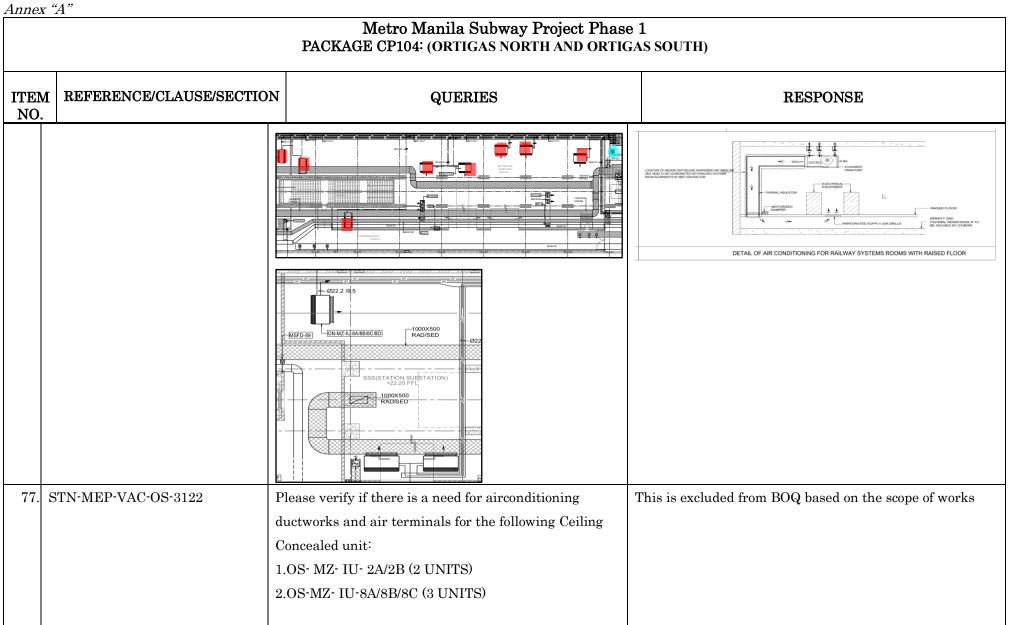

	Metro Manila Subway Project Phase 1 PACKAGE CP104: (ORTIGAS NORTH AND ORTIGAS SOUTH)						
ITEM NO.	REFERENCE/CLAUSE/SECTION	QUERIES	RESPONSE				
		If yes, please provide detailed ducting layout with specific Air terminal Grille Size.					
		PRD-09 PRD-09 PRD-09 UP FAG-15 Ø15.9/9.5 OS-MZ-IU-2A/2B VPS ROOM 100 Sqm Ø28.6/15.9 S					

	Metro Manila Subway Project Phase 1 PACKAGE CP104: (ORTIGAS NORTH AND ORTIGAS SOUTH)						
ITEM NO.	REFERENCE/CLAUSE/SECTION	QUERIES	RESPONSE				
		OS-MZ-IU-3A/8B/8C       OS-MZ-IU-3A/8B/8C       I6000X800 CUTOUT       HN FLOOR FOR       RETURN AIR DUCT       Y22.83 FFL       FAG-12       SSS (STATION)       SUBSTATION)       190 Sqm       Ø34.9/19.1       Ø22.6/9.5					

	Volume IV. Part 3 - Conditions of Contract and Contract Forms							
78.	Section VIII Particular Conditions	May the Employer and the Contractor agree to an	It would be acceptable if the Bidder proves the PI					
	(PC)	appropriate insurance in case the PI Insurance for	Insurance for major temporary works not accepted by the					
	PC-10	major temporary works not accepted by the global	global reinsurance market					
	6. Professional Indemnity	reinsurance market?						
	Insurance							

	Metro Manila Subway Project Phase 1 PACKAGE CP104: (ORTIGAS NORTH AND ORTIGAS SOUTH)						
ITEN NO.		N QUERIES	RESPONSE				
	GBB No.6 Item no.21						