| | Metro Manila Subway Project Phase 1 PACKAGE CP104: (ORTIGAS NORTH AND ORTIGAS SOUTH) | | | | | | | | | |
|-------------|---|--|--|--|--|--|--|--|--|--|
| ITEN NO. | | | QUERIES | RESPONSE | | | | | | |
| | | | Volume I Part 1 : Bidding Procedures | | | | | | | |
| 1. | Section II Bid Data Sheet (BDS) BDS-4 ITB 14.7 | | would like to confirm if payment of documentary for Insurance policy shall also be exempted or not. | The costs of stamp duties and similar charges (if any) imposed by law in connection with entry into the Contract Agreement shall be borne by the Employer. | | | | | | |

| | Volume IA Part 1 : Bidding Procedures Section IV Bidding Form-Bill of Quantities (BOQ) | | | | | | | | |
|----|---|---|--|--|--|--|--|--|--|
| 2. | 118 | BOQ Items G118(4) is for payment of the Environmental | Item $G118(5)$ is deleted from BOQ . | | | | | | |
| | G118(4) G118(5) | Guarantee Fund (EGF) and G118(5) is for the | | | | | | | |
| | Environmental Monitoring | Environmental Monitoring Fund (EMF). | Please refer to "BOQ Bill No.1" in Annex C of this GBB | | | | | | |
| | Fund and Environmental | However in the GS Section 118 there is no mention of the | | | | | | | |
| | Guarantee Fund. | Environmental Monitoring Fund. Please provide a | | | | | | | |
| | | specification and method of payment for the EMF. | | | | | | | |
| 3. | Discrepancies between the | Please confirm that where quantities on drawings differ | Please refer to the latest BOQ in GBB 10 and GBB11 | | | | | | |
| | Specifications and the Bills of | from quantities in the BOQ, then unit rates should be | | | | | | | |
| | Quantity | calculated based on quantities in the BOQ. | | | | | | | |
| 4. | Pay Item 800 Hardscape | We also would like to request for the techical specifications | Concrete pavers, Napoli Stone and Granite Stone have | | | | | | |

| | | | Metro Manila Subway Project Phas PACKAGE CP104: (ORTIGAS NORTH AND ORTIG | | ГН) | | |
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| ITEN NO. | ITEM REFERENCE/CLAUSE/SECTIO | | QUERIES | RESPONSE | | | |
| | | Does F pay ite F F | Pay item 800 hardscape also refers to the following ems under Bill No 6 - Station Plaza? Please clarify. Pay Item 1057 Concrete Pavers Pay Item Napoli Stone Pay Item 1018 Granite Stone | 613 616 614 615 The hard | 613 616 614 615 dscape refers to efer to below scr Sc All All All | he under Finishes. Paver Blocks 300x300x50mm Tactile Napoli Stone Granito Tile the allowances under "Softscape". reenshot. offscape owance for Plantboxes owance for Plantboxes owance for Benches owance for Park Furnitures | |
| 5. | Bill of Quantities Bill 7 1018(8)a 300x300mm yellow directional tactile1018(8)b 300x300mm yellow hazard warning tactile | iItem this It | e drawing shown below (SPL-C-RD-OS-1032) is for Pay 1018(8)a and Pay iItem 1018(8)b? Please confirm if tem is Stainless Steel Tactile and what color. | | | has its own pay item in the BOQ | |
| 6. | Bill of Quantities Bill 5A, Item 1203 (1) STN -MEP-VAC-ON-3811 | Please prevai | clarify which of the following conflict items shall l: | | CBBB10 uses 10.3 PE-1; Passenger Elev and rear opening, 10.3 | 99m. valor, 1600kg, 2stops/openings, Front 99m traveling ht, 60 m/m speed, set 1.00 | |

| | | PA | | | ay Project F ORTH AND O | Phase 1 ORTIGAS SOUTH) |
|-------------|--|---|---------------------|---------------------------------|----------------------------|---|
| ITEN NO. | | CTION | | QUERIES | | RESPONSE |
| | | Descriptio | n As per MEP Pla | As per an Architecto Plan | | вод |
| | | North Station ELEV-01 Traveling Hei | 10.99 meters ght | Not reflecte | ed 6.3 meters | S |
| 7. | Bill of Quantities Bill 5A, Item 1203 (1) | Please clarify which of the following conflict items shall prevail: | | | | BOQ in GBB10 uses 11.54m. 1203 1203(1) PE-2; Passenger Elevator, 1600kg, 3stops, 2front / 1rear opening; 11.54m traveling ht, 60 m/m speed set 1.00 |
| | STN -MEP-VAC-ON-3812, | Description | As per MEP Plan | As per Architectural Plan | As per BOQ | |
| | STN-AR-ON-9671 | North Station ELEV-02 Traveling Heigl | 11.54 meters | 11.54 meters | 19.94 meters | |
| 8. | Bill of Quantities Bill 5A, | Please clari | fy which of the fo | llowing confli | ct items shall | Escalator step width shall be minimum 1000 mm. |
| | Item 1233 (1) | Description | As per MEP Plan | As per Architectural Plan | As per BOQ | However, BOQ description provides total width of escalator requirements including housing. |
| | MEP-VAC-ON-3822, MEP- VAC-ON-3823, MEP-AR-A- ON-1001 | North Station ESCA 1 & 2 Step width | 1010 mm | 1000 mm | 1550 mm | |

| | | PA | | | way Project F NORTH AND O | Phase 1 PRTIGAS SOUTH) |
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| ITE NO | 1 REFERENCE/CLAUSE/SECTION | | QUERIES | | | RESPONSE |
| 9. | Bill of Quantities Bill 5A, | prevail: Please clarif | y which of the fo | ollowing confl | ict items shall | Escalator step width shall be minimum 1000 mm. |
| | Item 1233 (1) MEP-VAC-ON-3825, MEP- | prevail: Description | As per MEP Plan | As per Architectural Plan | As per BOQ | However, BOQ description provides total width of escalator requirements including housing. |
| | VAC-ON-3826, STN-AR-A- ON-1002 | North Station ESCA 3 & 4 Step width | 1010 mm | 1000 mm | 1550 mm | Please refer to the MEP Plan Drawing below: NOTE: This DRAWING IS NOIGHTIVE ONLY AND FURTHER COORDINATION WITH RESPECTIVE SCALARDY EVENOR SHALL BE REQUIRED. TECHNICAL SPECIFICATION VISION FOR THE REPORT OF T |
| | | | | | | MOVING HANDRAIL IGHT IGLASS PANEL WORKING LINE UBGHT UNDER HANDRAIL IGHT IGHT IGHT IGHT IGHT IGHT IGHT IGHT |

| million | 11 | | | | | | | | | |
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| | Metro Manila Subway Project Phase 1 PACKAGE CP104: (ORTIGAS NORTH AND ORTIGAS SOUTH) | | | | | | | | | |
| ITEM NO. | REFERENCE/CLAUSE/SECTION | QUERIES | RESPONSE | | | | | | | |
| | | | METRO MANILA SUBWAY PROJECT PHASE1 PACKAGE CP 104 Ortigas North Station Facelator No. 2.8.4 (Sheet 2) | DATE August 2020 SCALE AS SHOWN SHEET No. DRG No. STN-MEP-VAC-ON-3825 DRG S. REV 4 | | | | | | |

| | Metro Manila Subway Project Phase 1 PACKAGE CP104: (ORTIGAS NORTH AND ORTIGAS SOUTH) | | | | | | | | |
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| | Metro Manila Subway Project Phase 1 PACKAGE CP104: (ORTIGAS NORTH AND ORTIGAS SOUTH) | | | | | | | | | |
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| ITEN NO | | E/SECTION QUERIES | | | RESPONSE | | | | | |
| | | | | | | METRO MANILA SUBWAY PROJECT PHASE1 DATE SCALE PACKAGE CP 104 SHEET No. Ortigas North Station Escalator No. 3 & 4 (Sheet 3) DRG No. STN-MEP-VAC-ON-3826 DRG S. REV 4 | | | | |
| 10. | Bill of Quantities Bill 5A, | | which of the follo | wing conflict i | tems shall | Escalator step width shall be minimum 1000 mm. | | | | |
| | Item 1233 (1)STN-AR-A-ON- | prevail: | | | | However, BOQ description provides total width of | | | | |
| | 1002 to STN-AR-A-ON-1004, STN-MEP-VAC-ON-3828, | Description | As per MEP Plan | As per Architectural Plan | As per BOQ | escalator requirements including housing. Please Refer to MEP Plan Drawing below | | | | |
| | STN-MEP-VAC-ON-3829 | North Station ESCA 5 - 8 Step width | 1010 mm | 1000 mm | 1550 mm | | | | | |


| | Metro Manila Subway Project Phase 1 PACKAGE CP104: (ORTIGAS NORTH AND ORTIGAS SOUTH) | | | | | | | | |
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| ITEM NO. | REFERENCE/CLAUSE/SECTION | | QUERIES | RESPONSE | | | | | |
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| Metro Manila Subway Project Phase 1 PACKAGE CP104: (ORTIGAS NORTH AND ORTIGAS SOUTH) | | | | | | | |
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| ITEM NO. | REFERENCE/CLAUSE/SECTION | QUERIES | RESPONSE | | | | |
| | | | NOTE : THIS DRAWING IS INDICATIVE ONLY AND FURTHER COORDINATION WITH RESPECTIVE ESCALATOR VENDOR SHALL BE REQUIRED. TECHNICAL SPECIFICATION SECTION 1233 NEEDS TO BE REFERRED FOR TECHNICAL PARTICULAR OF ESCALATOR. DURING CONSTRUCTION, ARCHITECTURE (STRUCTURE) CONTRACTOR NEED TO FURTHER COORDINATION WITH SELECTED ESCALATOR VENDOR FOR FIXING ARRANGEMENT OF MOUNTING PLATE. | | | | |
| | | | | | | | |

| | | PAC | Metro Ma KAGE CP104: (| | y Project Ph DRTH AND OR | |
|-------------|---|---|--------------------------------------|---|--|--|
| ITEM NO. | REFERENCE/CLAUSE/SE | CTION | ON QUERIES | | | RESPONSE |
| | Bill of Quantities Bill 5B, Item 1203 (1) STN -MEP-VAC-OS-3811 | Please clarify prevail: Description South Station ELEV-01 Traveling Height | which of the foll As per MEP Plan | lowing conflict As per Architectural Plan Not reflected | items shall As per BOQ 6.3 meters | METRO MANILA SUBWAY PROJECT DATE PHASE1 SCALE August 2020 SCALE AS SHOWN BHEET No. Driggas North Station Escalator No. 5,6,7 & 8 (Sheet 3) DrG No. STN-MEP-VAC-ON-3829 DrG S. PRG S. Ref August 2020 Ref As SHOWN String North Bread of the string North Station DrG No. STN-MEP-VAC-ON-3829 DrG S. PRG S. Ref 4 4 |
| | Bill of Quantities Bill 5B, Item 1203 (1) STN -MEP-VAC-OS-3812, STN-AR-OS-9671 | Please clarify prevail: | which of the foll | lowing conflict | items shall | Refer to BOQ in GBB 10. It shall be 11.54m. 1203 1203(1) PE-2; Passenger Elevator, 1600kg, 3stops/openings, front and rear opening; 11.54m traveling ht, 60 m/m speed set 1.00 |

| Annez | Metro Manila Subway Project Phase 1 PACKAGE CP104: (ORTIGAS NORTH AND ORTIGAS SOUTH) | | | | | | | |
|------------|---|---|--|--|---|-----------|--|----------|
| ITEN NO | | CTION | | | QUERII | ES | | RESPONSE |
| | | Descriptior | | As per MEP F | As per Per MEP Plan Architectural As per I Plan | | As per | |
| | | | outh Station LEV-02 11.54 meters 11.54 meter raveling Height | | .54 meters | 19.94 met | | |
| 13. | Bill of Quantities Bill 5B, Item 1203 (1) | Please clarify which of the following conflict items shall prevail: | | | | | Refer to BOQ in GBB 10. It shall be 3steps, 2front/ 1 rear 1203 1203(1) PE-2; Passenger Elevator, 1600kg, 3stops/openings, front and rear opening; 11.54m traveling ht, 60 m/m speed set | |
| | STN-AR-A-OS-9671, STN- MEP-VAC-OS-3812 | South Station 3 stops 2 front / 1 3 stops 2 front / | | | | | s/ opening | |
| 14. | Bill of Quantities Bill 5B,Please clarify which of the following conflict items shallItem 1233 (1)MEP-VAC-OS-prevail:3822, MEP-VAC-OS-3823,HEP-AR-A-OS-1001 | | | Escalator step width shall be minimum 1000 mm. However, BOQ description provides total width of escalator requirements including housing. Please refer to MEP Plan Drawing Below. | | | | |





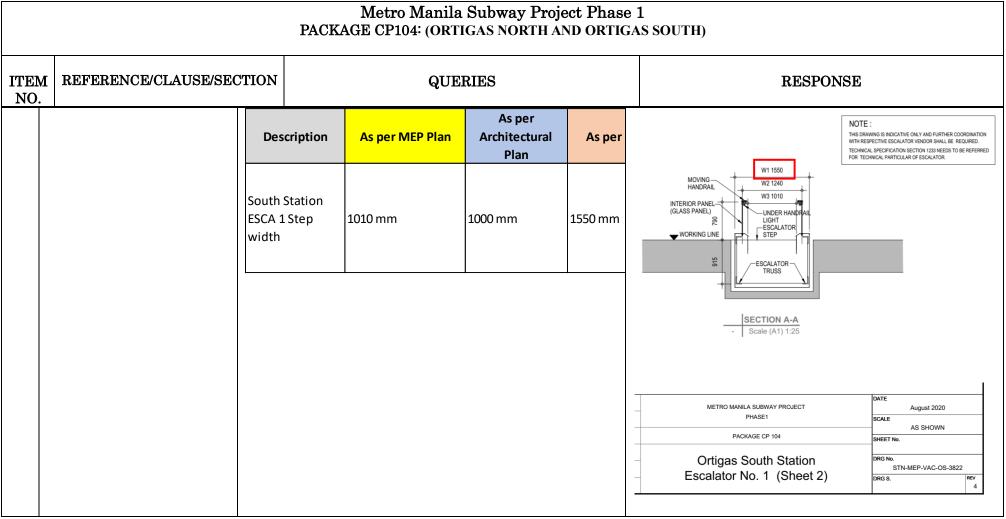

| | Metro Manila Subway Project Phase 1 PACKAGE CP104: (ORTIGAS NORTH AND ORTIGAS SOUTH) | | | | | | |
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| AIIIIe2 | Metro Manila Subway Project Phase 1 PACKAGE CP104: (ORTIGAS NORTH AND ORTIGAS SOUTH) | | | | | | |
|------------|---|-----------------------------|--|-----------------|--|--|--|
| ITEN NO | I REFERENCE/CLAUSE/SECTIO | | CTION QUERIES | | RESPONSE | | |
| 15. | Pay Item 1032 Painting, Varniching and other Related Works | Anti G | uld like to clarify if all painted areas are required for raffiti Coating. If not, may we request a schedule for raffiti Coating. | not ii 1032. | METRO MANILA SUBWAY PROJECT PHASE1 DATE August 2020 PACKAGE CP 104 SHEET NO. Ortigas South Station Escalator No. 1 (Sheet 3) ORG NO. STN-MEP-VAC-OS-3823 graffiti coating on drawings is not identified. TS does nclude Anti-graffiti coating on Products (TS Section .2.1) and Pay Item schedule (TS Section 1032.4.2) aint in public area (paid and unpaid) since all wall | | |
| 16. | 2010(1) Evacuation Passage, Handrail and Step | Civil F specifi Work. | pay item the same as the Emergency Stairs on the Plan Station Drawings? If so, please clarify the cations since the this pay item is under 2010 Steel May we also request for the detailed drawing for acuation passage mentioned. | The H | nes are stone finishes Pay item 2010(1) is for Evacuation Passage on CN-CE- 015 and other relevant drawings. Not for Emergency s. | | |
| 17. | Bill of Quantities pay item 1113(2a) | Please | provide details for Capacitor Banks and External y System. | & 01 | Capacitor Bank Electrical schematic drawing (OS-2001 N-2001) needs to be referred. For UPS system 2 hrs ery Back backup has been considered. | | |

| | Metro Manila Subway Project Phase 1 PACKAGE CP104: (ORTIGAS NORTH AND ORTIGAS SOUTH) | | | | | | |
|-------------|---|---------|--|--|--|--|--|
| ITEN NO. | A REFERENCE/CLAUSE/SEC | CTION | QUERIES | RESPONSE | | | |
| 18. | Bill of Quantities, Bill 2A and | Please | provide existing Plans, details and relocation lay-out | Location and details shall comply with relevant authorities' | | | |
| | Bill 2B, Item No. 2005 | for the | se items to be reinstated/relocated (Single Arm Street | requirements. | | | |
| | | Lighti | ng) | | | | |
| 19. | Bill of Quantities, Bill 4A and | As per | Bill of Quantities, Alarm Reset Button and Alarm | Alarm Reset Button and Alarm Pull chord were removed. | | | |
| | Bill 4B, Item No. 1002 | Pull C | hord (2 Bangles) are reflected but there are no plans | The items were deleted in Revised BOQ. | | | |
| | | and sp | pecifications. Please clarify if this is part of scope. If | | | | |
| | | yes, pl | ease provide location on plans and its specifications. | | | | |
| 20. | BILL NO. 4a & 4b | May w | ve request a separate drawing details (Size, profile, | It is considered in BOQ with Pay Item no. 1804 (1) under | | | |
| | | and co | nfigurations) for the item "Extruded Aluminum | Metal Louvers and located entrances and outdoor | | | |
| | Metal Louvers | Vertic | al Louvers". | machinery. | | | |
| | | | | Please refer to Drawing Sheet No. STA-AR-A-ON/OS-9240 | | | |
| | Pay Item no. 1804 (1) | | | (Typical Details); ON:STN-AR-A-ON-6033 to STN-AR-A- | | | |
| | Extruded Aluminum Vertical | | | ON-6047 & OS: STN-AR-A-OS-6007 to STN-AR-A-OS-6019 | | | |
| | Louvers | | | | | | |
| 21. | BILL NO. 4a & 4b | May w | ve request a separate drawing details (Size, profile, | It is considered in BOQ with Pay Item no. 1804 (2) located | | | |
| | | and co | nfigurations) for the item "Extruded Aluminum | at elevator shaft. | | | |
| | Metal Louvers | Horizo | ontal Louvers with Insect Screen". | Please refer to Drawing Sheet No. STA-AR-A-ON/OS-9131 | | | |

| | Metro Manila Subway Project Phase 1 PACKAGE CP104: (ORTIGAS NORTH AND ORTIGAS SOUTH) | | | | | |
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| ITEN NO. | | TION QUERIE | S RESPONSE | | | |
| | Pay Item no. 1804 (1) Extruded Aluminum Horizontal Louvers with Insect Screen | | (Typical Details); ON: STN-AR-A-ON-7000;STN-AR-A-ON 7001 & OS: STN-AR-A-OS-7000; STN-AR-A-OS-7001 | | | |
| 22. | BILL NO. 4a & 4b Metal Louvers | May we request a separate drawing det and configurations) for the item "Extrac Louver with Insect Screen" . | | | | |
| | Pay Item no. 1804 (1) Extract Air Aluminum Louver with Insect Screen | | 5102; STN-AR-A-ON-5106 & OS: STN-AR-A-OS-5100 STN-AR-A-OS-5102; STN-AR-A-OS-5106 | | | |

| | Metro Manila Subway Project Phase 1 PACKAGE CP104: (ORTIGAS NORTH AND ORTIGAS SOUTH) | | | | | | |
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| ITEN NO. | A REFERENCE/CLAUSE/SE | CTION | QUERIES | RESPONSE | | | |
| | | | | Image: Sector | | | |
| 23. | BILL NO. 4a & 4b | May w | e request a finishing Schedule, Locations and | Please refer to drawing sheet no. STA-AR-A- ON/OS-9060 | | | |
| | | Drawi | ngs details for the item "Aluminum Composite Panel | "Detail-C". | | | |
| | Ceiling Works | Claddi | ng ". | Aluminum panels are used only at entrance locations. | | | |
| | Pay Item no. 1811 (9) Aluminum Composite Panel Cladding | | | A DETERT - C | | | |

| | Metro Manila Subway Project Phase 1 PACKAGE CP104: (ORTIGAS NORTH AND ORTIGAS SOUTH) | | | | | | | |
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| ITEN NO. | A REFERENCE/CLAUSE/SE | CTION | QUERIES | RESPONSE | | | | |
| 24. | BILL NO. 4a & 4b | As sta | ted on the provided Technical Specifications (File | 12mm thk for toilet partition while 18mm thk is used for | | | | |
| | | Page:6 | 671 / PDF Page:687): | operable wall partitions. Please see drawing sheet no. STA- | | | | |
| | Phenolic Partitions | | | AR-A-OS/ON-9501. | | | | |
| | Pay Item no. 1816 (1) a3 | Desc | ription: 12 mm thick high pressure-laminate (HPL) 18 | | | | | |
| | 1816 (1) a1 | mm th | ick phenolic board toilet/urinal partition and toilet | Please refer to BOQ Pay Item No. 1816 (1) a1, 1816 (1) a2 | | | | |
| | 1816 (1) a2 | door, f | loor-mounted,including hinged doors, front pilasters, | and 1816 (1) a3. | | | | |
| | Phenolic Partition - Shower | pedest | als including accessories to complete the assembly | | | | | |
| | Partition and fix | | king to building structure. | | | | | |
| | Phenolic Partition - Toilet | | | | | | | |
| | Partition | We we | ould like to clarify that the Phenolic Board is 18mm | | | | | |
| | Phenolic Partition - Urinal | THK a | and the High Pressure-Laminate is 12mm THK which | | | | | |
| | Partition | means | 12mm HPL + 18mm Phenolic board + 12mm HPL is | | | | | |
| | | the co | mplete set of finish $(12 + 18 + 12 = 42 \text{mm thk})$ for the | | | | | |
| | | partito | ons. | | | | | |
| | | | | | | | | |
| | | Please | Clarify. | | | | | |
| 25. | BILL NO. 4a & 4b | May w | ve request a Fire Rated Rooms Schedule indicating | Fire rated construction for rooms are indicated in drawing, | | | | |
| | Room Fire Rating hours | requir | ed fire rating hours. | please see drawing sheet no. STA-AR-A-OS/ON-0600/0601. | | | | |
| | Intumescent Painting | | | Intumescent coating is only used for steel structural | | | | |
| | | | | members of glass shaft elevator from B1F to B3F. | | | | |

| Annez | Metro Manila Subway Project Phase 1 PACKAGE CP104: (ORTIGAS NORTH AND ORTIGAS SOUTH) | | | | | | | |
|------------|--|--|---|--|--|--|--|--|
| ITEN NO | REFERENCE/CLAUSE/SECTION | | QUERIES | RESPONSE | | | | |
| 26. | 3. CP104 BOQ As point table_10Dec2020_Bill.No.2,3, 4,5 / Bill 5 A / 1126 Telep (7),1126(8), Bid I confi confi | | Technical Specifications, Main Distribution Frame (MDF) and Distribution Frames (IDF) are by none service provider. However, it is still reflected in alletin No.5, Revised Bill of Quantities. Kindly in if we will still provide cost for these items. If yes, we like to request for the technical specifications | 1127.2.4 "MDF Room" should be corrected as "Telecom Room". The scope of the telephone service provider should be clearly shown in the relevant drawings. Demarcation NOTE in MEP drawings shall be modified. Kindly refer to updated BOQ. TEL and LAN system only includes cable trays and conduits. | | | | |
| 27. | Specifications, Section 1126 27. CP104 BOQ As p table_10Dec2020_Bill.No.2,3, plate 4,5 / Bill 5 A / 1126 device (6a) ,1126(6b) , Bulle | | r Technical Specifications, telephone jacks and face are by Telephone service provider. However, field s such as telephone outlets are still reflected in Bid in No.5, Revised Bill of Quantities. Kindly confirm if l still provide cost for these items. If yes, we would like test for the technical specifications | The scope of the telephone service provider should be clearly shown in the relevant drawings. Demarcation NOTE in MEP drawings shall be modified. These are excluded in the updated BOQ. | | | | |

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|-------------|---|--|---|---|
| ITEN NO. | | CTION | QUERIES | RESPONSE |
| | MEP Technical Specifications, Section 1126 | | | |
| 28. | CP104 BOQ table_10Dec2020_Bill.No.2,3, 4,5 / Bill 5 A / 1127 (6) | test ar softwa | Technical Specifications, "Design, supply, install, ad commission of all equipment (hardware and re), cables, materials and interfaces required to ete the Local Area Network System (LAN System) are | The scope of the telephone service provider should be clearly shown in the relevant drawings. Demarcation NOTE in MEP drawings shall be modified. |
| | CP104 BOQ table_10Dec2020_Bill.No.2,3, 4,5 / Bill 5 B / 1127 (6) MEP Technical Specifications, Section 1127 | Bullet as LAI still pr | ephone service provider". However, as per Bid in No.5, Revised Bill of Quantities, field devices such N outlet are still reflected. Kindly confirm if we will rovide cost for these items. If yes, we would like to at for the technical specifications | Kindly refer to updated BOQ. TEL and LAN system only includes cable trays and conduits. |
| 29. | | test ar softwa comple by Tel Bullet Distril | Technical Specifications, "Design, supply, install, ad commission of all equipment (hardware and re), cables, materials and interfaces required to ete the Local Area Network System (LAN System) are ephone service provider". However, as per Bid in No.5, Revised Bill of Quantities, Intermediate pution Frame (IDF) are still reflected. Kindly confirm will still provide cost for these items. If yes, we would | The scope of the telephone service provider should be clearly shown in the relevant drawings. Demarcation NOTE in MEP drawings shall be modified. Kindly refer to updated BOQ. TEL and LAN system only includes cable trays and conduits. |

| Annex | Metro Manila Subway Project Phase 1 PACKAGE CP104: (ORTIGAS NORTH AND ORTIGAS SOUTH) | | | | | | |
|-------------|---|---------|---|--|--|--|--|
| ITEN NO. | | CTION | QUERIES | RESPONSE | | | |
| | MEP Technical | like to | request for the technical specifications | | | | |
| | Specifications, Section 1127 | | | | | | |
| 30. | CP104 BOQ | As per | Technical Specifications, "Master Antenna Television | The scope of the telephone service provider should be | | | |
| | table_10Dec2020_Bill.No.2,3, | Syster | n are by Telephone service provider". However, as per | clearly shown in the relevant drawings. Demarcation | | | |
| | 4,5 / Bill 5 A / 1125 (1-7) | Bid Bu | alletin No.5, Revised Bill of Quantities, Pay Item | NOTE in MEP drawings shall be modified. | | | |
| | | 1125, | there are line items dedicated for MATV System such | | | | |
| | CP104 BOQ | as Cal | le Ladders, riser cables, conduits, field devices such | Kindly refer to updated BOQ. MATV is already excluded. | | | |
| | table_10Dec2020_Bill.No.2,3, | as TV | Outlets, MATV Head End Equipment and Pullbox. | | | | |
| | 4,5 / Bill 5 B / 1125 (1-7) | Kindly | v confirm if we will still provide cost for these items. If | | | | |
| | | yes, w | e would like to request for the technical specifications | | | | |
| | MEP Technical | | | | | | |
| | Specifications, Section 1125 | | | | | | |
| 31. | CP104 BOQ | Please | provide reference plans for the new line item in | BOQ based the pay item on the following drawing STN- | | | |
| | table_10Dec2020_Bill.No.2,3, | Revise | ed BOQ at Bid Bulletin No.5, "Tunnel Fireman's | MEP-FPS-TUN8-3111; 3112; 2101 | | | |
| | 4,5 / Bill 5 A / 1123 (7) | Teleph | none including necessary controls, conduits and | | | | |
| | | wiring | s as required". | | | | |
| | CP104 BOQ | | | | | | |
| | table_10Dec2020_Bill.No.2,3, | | | | | | |
| | 4,5 / Bill 5 B / 1123 (7) | | | | | | |
| 32. | Bill of Quantities Bill 5A, | Please | clarify which type of fire extinguishers will be used | BOQ in GBB10 followed latest plans and Fire Extinguisher | | | |
| | Bill of Quantities Bill 5B, | since t | here are conflict between the Original BOQ, Revised | schedule | | | |

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| <u>AIIIICA</u> | | Metro Manila Subway Project Pha PACKAGE CP104: (ORTIGAS NORTH AND ORT | |
|----------------|----------------------------------|--|--|
| ITEN NO. | A REFERENCE/CLAUSE/SEC | QUERIES | RESPONSE |
| | STN-MEP-FPS-CWD-0102 | BOQ, and Plans. | Portable fire extinguisher, including supporting frames or brackets and all other necessary accessories pc 88.00 1202 1202(9) FEX - Dry Chemical type, ABC class, 4.54kg pc 88.00 1202 1202(7) FEX - CO2 type, 4.54kg pc 21.00 1202 1202(8) WFEX - Foan Wheeled, ABC class, 22.68kg pc 1.00 |
| | | Pay Item Original BOQ Revised BOQ As Per Plan | 1202 1202(7) WFEX - CO2 type, 22.68kg pc 1.00 |
| | | 1202(8) FEX - Clean gas type, 4.54kg FEX - CO2 type, 4.54kg FEX - Clean Gas Type, 4.54kg | Portable fire extinguisher; including supporting frames or brackets and all other necessary accessories |
| | | 1202(6) WFEX - ABC class, 22.68kg WFEX - Dry chemical type, ABC class, 22.68kg WFEX - Foam Type, 22.68kg | 1202 1202(9) FEX - Dry Chemical type, ABC class, 4.54kg pc 79.00 1202 1202(8) FEX - Clean Gas type, 4.54kg pc 17.00 1202 1202(9) WFEX - Dry chemical type, ABC class, 22.68kg pc 1.00 1202 1202(8) WFEX - Clean Gas type, 22.68kg pc 1.00 |
| | | 1202(8) WFEX - Clean gas type, 22.68kg WFEX - CO2 type, 22.68kg WFEX - Clean Gas Type, 22.68kg | |
| 33. | CP104 BOQ | Kindly clarify if whose scope is the supply and installation of | f BOQ followed the Tech Specs showing "By Civil Contractor" |
| | table_10Dec2020_Bill.No.2,3, | 400mm2 Copper Strip Grounding Mat. As per Specs | , |
| | 4,5 / Bill 5 A / 1122 (2) | Schematic Diagram and Electrical Revised BOQ (Bid | 1 |
| | | Bulletin No.5), it is by Civil Scope. However, it is not reflected | 1 |
| | | on Civil Structural and Architectural Pay Item/BOQ. | |
| | | Description Tech Specs Plans Electrical BOQ Civil BOQ | |
| | | 400mm2 Copper Strip By Civil Contractor Not reflected By Civil Contractor Not reflected | |
| 34. | CP104 BOQ | As per Original BOQ, there is a separate Bill for Tunnel | 5A/5B BOQ excluded Tunnel Lighting System based on the |
| | table_10Dec2020_Bill.No.2,3, | Lighting System (Bill 8). However, in Revised BOQ (Bid | scope of works |
| | 4,5 / Bill 5 A / 1121 (a) / Bill | Bulletin No.5), there is a new line item for Tunnel Lightings | 3 |
| | 5B / 1121 (a) | and outlets reflected in Bill 5A and Bill 5B. Kindly confirm | |
| | 01_CP104_P1_S(IA)_(BF- | if both items are the same. If yes, please verify if we will | |
| | BOQ)_16Sep2020_rev / Bill 8 | still consider the Bill 8 (Tunnel Lighting System). | |
| 35. | STN-MEP-ELL-ON-2012 | As per BOQ, Lighting fixtures for A1, A5 and B1 has no | DB schedule and Dialux report need to be referred for |
| · · · · | | Page 22 of 60 | |

| | Metro Manila Subway Project Phase 1 PACKAGE CP104: (ORTIGAS NORTH AND ORTIGAS SOUTH) | | | | | | |
|---------------------------------------|---|--|--|----------------------------------|--|--|--|
| ITEM REFERENCE/CLAUSE/SECTION QUERIES | | | | RESPONSE | | | |
| | CP104 BOQ | P104 BOQ wattage ratings. But as per plan, each type of lighting | | quantity and wattage of fixture. | | | |
| | table_10Dec2020_Bill.No.2,3, | fixture | has a designated wattage ratings, e.g. Type A1 has a | | | | |
| | 4,5 / Bill 5 A / 1118 (a) / 1118 | wattag | e rating of 53 Watts and 34 Watts, which has | | | | |
| | (b) / 1118 (li) / 1118 (lk) / | differe | nt cost. Kindly advise which wattage will be | | | | |
| | 1118 (ll) / 1118 (lm) | consid | ered in the cost. | | | | |

| | Volume III Part 2 : Works Requirements Section VI Works Requirements General Specifications (GS) | | | | | |
|-----|---|---|--|--|--|--|
| 36. | GS 189 | Please provide the requirements of the timing and | Deleted Appendix 2 _9.4 a) vii) FIT (Final Integration Test) | | | |
| | Appendix 1 | duration of the Operation and Maintenance Period. | | | | |
| | 9.4 a) vii) | | | | | |
| | Final Integration Test | | | | | |
| | FIT shall be carried out at the end | | | | | |
| | of Operation and Maintenance | | | | | |
| | period. The Contractor shall | | | | | |
| | perform full system diagnostics test | | | | | |
| | to demonstrate that the system is | | | | | |
| | fully functional and have been | | | | | |
| | properly maintained. | | | | | |

| Annex | Metro Manila Subway Project Phase 1 PACKAGE CP104: (ORTIGAS NORTH AND ORTIGAS SOUTH) | | | | |
|-------------|---|--|---------------------------------|--|--|
| ITEM NO. | REFERENCE/CLAUSE/SECTION | QUERIES | RESPONSE | | |
| | | Volume III Part 2 : Works Requirements Section VI Works RequirementsTechnical Specifica | | | |
| | | 1 Civil | | | |
| 37. V | Vol. II, Part 2: Works Requirements/ | Pages BOQ-208 and BOQ-211: | These are clerical errors only. | | |
| 7 | Technical Specifications (TS), 1: Civil | | | | |
| ۲ | Works (General) | 1) There are Pay Items 301(1) with incorrect item | | | |
| ŗ | p. 53 p. 86 | description, and with quantities while it is | | | |
| ę | 301- | indicated "not used" in technical specification. | | | |
| I | Bituminous Prime Coat | 2) There are Pay Items description of "PCC | | | |
| I | Basis of Payment | Pavement (Unreinforced)" but Item Nos. are | | | |
| ~~ | 'Not Used." | incorrect. | | | |
| | | Are these clerical errors only? Please clarify. | | | |
| I | Bill of Quantities (BOQ) a part of | | | | |
| S | Section IV, Bidding Forms | | | | |
| ŗ | p. BOQ-208 & 211 | | | | |
| I | Part D: Building Works/ D.1 | | | | |
| S | Structural Works | | | | |
| I | Item 310(1)- | | | | |
| I | PCC Pavement (Unreinforced), m ³ | | | | |
| 38. V | Vol. II, Part 2: Works | Pages BOQ-208 and BOQ-211: | These are clerical errors only. | | |

| Annex | Metro Manila Subway Project Phase 1 PACKAGE CP104: (ORTIGAS NORTH AND ORTIGAS SOUTH) | | | | |
|-------------|---|--|--|--|--|
| ITEM NO. | REFERENCE/CLAUSE/SECTION | QUERIES | RESPONSE | | |
| | Requirements/Technical | | | | |
| | Specifications (TS), 1: Civil Works | There are Pay Items 400(1), 400(2), 400(5), 400(6), | | | |
| | (General) | 405(2), 402(1&2), 405(1), and 414 but Part 4- Bridge | | | |
| | p. 90 Part 4 | Construction is indicated "not used" in technical | | | |
| | BRIDGE CONSTRUCTION | specification. | | | |
| | Not Used." | | | | |
| | | Please clarify. | | | |
| | Bill of Quantities (BOQ) a part of | | | | |
| | Section IV, Bidding Forms | | | | |
| | p. BOQ-208 & 211 | | | | |
| | Part D: Building Works | | | | |
| | D.1 Structural Works | | | | |
| 30 | BOQ | Please provide the drawings describing the scope of | Please refer to drawing sheet no. STA-AR-A- ON-9060 | | |
| | BOQ Bill No. 4A & 4B | the Aluminum Composite Panel Cladding. | "Detail-C". | | |
| | | the Alumnum Composite Faner Clauding. | | | |
| | 1811 | | Aluminum panels are used only at entrance locations. | | |
| | Aluminum Composite Panel | | | | |
| | Cladding | | Refer to TS Section 18112.1.3 and Pay Item 1811 (3) | | |

| -iiiiex | Metro Manila Subway Project Phase 1 PACKAGE CP104: (ORTIGAS NORTH AND ORTIGAS SOUTH) | | | | |
|-------------|--|---|---|--|--|
| ITEM NO. | REFERENCE/CLAUSE/SECTION | QUERIES | RESPONSE | | |
| | No drawings describing scope of the paint finish are found in both the North and South Stations. | | | | |
| | BOQ Bill No. 4A, 4B 1811 & Bill No. 7A 1039 Aluminum Composite Panel Cladding at the Stations and Pedestrian Bridge There are no specifications for the Aluminum Composite Panel Cladding found. | Please provide the specifications for the Aluminum Composite Panel Cladding. | Bill No. 4A, 4B 1811Refer to drawing sheet STN-AR-A-OS-9180, Detail Aregarding Aluminum Coping describe in TS Section1039.2.1 with Pay Item 1039Refer to drawing sheet STA-AR-A- ON-9060, Detail-Cregarding Aluminum Ceiling Panel describe in TS Section18112.1.3 with Pay Item 1811 (3) | | |
| 41. | TS2 Arch p604 to p606 1811.2.1 Armstrong Aluminum Ceiling Panels [:] CLG-1, CLG-2, CLG-3, CLG-6, CLG- 7 Manufacturer [:] Armstrong or approved equal or better. | We are unable to contact the manufacturer: Armstrong since their website show "Armstrong World Industries, Inc. has completed the sale of its EMEA and Pacific Rim businesses." Kindly provide us the contact and email address which are very reliable because these ceilings are very complicated due to ceiling depths as well as earthquake zone, and therefore probably be extremely expensive. | Material can be acquired/referenced to other suppliers that has similar or better specifications as indicated. Just for only Bidder's reference, below is the contact of Armstrong ceiling solutions brought by Knauf. Anthony B. Vargas, Country Manager Philippines. Email: <u>Vargas.Anthony@knaufmarketing.com</u> | | |

| | Metro Manila Subway Project Phase 1 PACKAGE CP104: (ORTIGAS NORTH AND ORTIGAS SOUTH) | | | | |
|-------------|---|---|---|--|--|
| ITEM NO. | REFERENCE/CLAUSE/SECTION | QUERIES | RESPONSE | | |
| 42. | TS2 Arch p296 to p299 | The requirements are proprietary specifications. | Granite stone can be referred to other suppliers that has | | |
| | 1018.6.1 | Therefore there will be no competitiveness in prices. | equal or better materials specifications matching the | | |
| | Granite Stones: FLG-01, FLG-01, | Please specify other granite stones which the | stones indicated. | | |
| | FLG-02, FLG-03, FLG-04, GTL-01, | bidders are able to select from a list of approved | Bidders can select/nominate different supplier/ | | |
| | GTL-02, GTL-03, GTL-04, GTL-05, | manufacturers in order to make prices competitive | Manufacturer as long as the size and color of granite stone | | |
| | SKT-01, In-laid Granite Stone | and to avoid increase of the project cost. | match the specifications. "Approved equal or better" is | | |
| | Directional Symbol with Metal Trim, | | indicated in the stone specifications to avoid reference to | | |
| | Granite Stone Threshold | | single supplier/Manufacturer. | | |
| | Manufacturer: Kaufmanstone or | | | | |
| | approved equal or better. | | Possible other comparative suppliers are "Euroasia" and | | |
| | | | "MultiRich" for your selection of competitive price. Just for | | |
| | | | Bidderr's/ contractor's reference only. | | |
| | | 2 Architecture | | | |
| 43. | Vol. II, Part 2: Works | Pages BOQ-208 and BOQ-211: | Item 802 (1) Unsuitable soil not applicable. | | |
| | Requirements/Technical | | | | |
| | Specifications (TS), 2: Architecture | There is Item 802 (1) with item description of "Fill | Pay Item 802(1) tagged as "Not Used "on TS in GBB 10 | | |
| | p. 54 | and Backfill", and with quantities while in the | | | |
| | Part 8: | Technical Specification, Item 802 (1) is Unsuitable | | | |
| | Earthwork | Excavation. | | | |
| | | | | | |
| | Item 802 | Please clarify. | | | |

| | Metro Manila Subway Project Phase 1 PACKAGE CP104: (ORTIGAS NORTH AND ORTIGAS SOUTH) | | | | |
|-------------|---|--|---|--|--|
| ITEM NO. | 1 REFERENCE/CLAUSE/SECTION | QUERIES | RESPONSE | | |
| | Excavation | | | | |
| | Item 802(1)- | | | | |
| | Unsuitable Excavation in Cubic | | | | |
| | Meter | | | | |
| | | | | | |
| | Bill of Quantities (BOQ) a part of | | | | |
| | Section IV, Bidding Forms | | | | |
| | p. BOQ-208 & 211 | | | | |
| | Part A: Earthworks | | | | |
| 44. | Arch | Please advise us how many group masters keys and | Minimum of 4 master keys for each group, and 4 keys for | | |
| | P175 | grand master keys you require. | grand master keys | | |
| | 1004.2.4 12) | | | | |
| | | | | | |
| | VI | | | | |
| | DWG | | | | |
| | Arch | | | | |
| | Master Keys | | | | |
| | DWG Nos. STN-AR-A-ON/OS-7007 | | | | |
| | to7011 | | | | |
| | The second last note in the drawings | | | | |
| | indicate "CONTRACTOR SHALL | | | | |

| Annex | Metro Manila Subway Project Phase 1 PACKAGE CP104: (ORTIGAS NORTH AND ORTIGAS SOUTH) | | | | |
|-------------|---|---|---|--|--|
| ITEM NO. | REFERENCE/CLAUSE/SECTION | QUERIES | RESPONSE | | |
| | PROVIDE 10 COPIES OF MASTER | | | | |
| | KEYS". | | | | |
| | However Item 12) of the | | | | |
| | specifications state the followings: | | | | |
| | "In general, provide for grand master | | | | |
| | keying. Provide at least 4 keys for | | | | |
| | each lock, 4 master keys for each | | | | |
| | group of locks, and 4 grand master | | | | |
| | keys, unless otherwise requested by | | | | |
| | the Employer." | | | | |
| 45. | TS2 Arch p176 & p181 | Despite of the statement in the specifications, there | Thresholds provided are similar to the floor finish where | | |
| | 1004.2.4 17) | are no aluminum thresholds with the sealant in Bill | the door is located. Refer to Pay item: | | |
| | 1004.3.3 11) | No. 4. Kindly provide the pay items and quantities. | | | |
| | | | 1018 (5) b9 Glazed Ceramic Tile – 200mm Threshold | | |
| | BOQ | | 1018 (3) a3 Granite Stone Honed Finish – 200mm | | |
| | Bill No. 4 | | Threshold | | |
| | Aluminum Thresholds with Sealant | | 1020 (3) Vinyl Tile – 200mm Threshold | | |
| | The specifications state the | | BOQ References: | | |
| | followings: | | OSS | | |
| | "In accordance with BHMA A156.21; | | 1018 (5) b9 Glazed Ceramic Tile – 200mm Threshold | | |

| | Metro Manila Subway Project Phase 1 PACKAGE CP104: (ORTIGAS NORTH AND ORTIGAS SOUTH) | | | | | |
|---|---|--|---|--|--|--|
| ITEM NO. | REFERENCE/CLAUSE/SECTION | QUERIES | RESPONSE | | | |
| in a d l e s h "" e in h t t in s | abricated to full width of opening ndicated. Thresholds shall be in luminum at exterior and interior loors and installed complete with ead shields using stainless steel crews, except washroom doors to have stone thresholds." and Thresholds: Set thresholds for xterior doors, and other doors indicated within the approved door hardware schedule and indicated on he Drawings, in full bed of sealant in accordance with requirements pecified in TS Section 1815 Sealants." | | 1018 1018 (5) b9 Gazed Ceranic Tile - 200mm Threshold In 19.95 1018 (3) a3 Granite Stone Honed Finish – 200mm Threshold In 19.95 1018 (3) a3 Granite Stone Honed Finish – 200mm Threshold In 11.58 0NS 1018 (5) b9 Glazed Ceramic Tile - 200mm Threshold In 11.58 0NS 1018 (5) b9 Glazed Ceramic Tile - 200mm Threshold In 11.58 0NS 1018 (5) b9 Glazed Ceramic Tile - 200mm Threshold In 24.80 1018 (3) a3 Granite Stone Honed Finish - 200mm Threshold In 24.80 1018 (3) a3 Granite Stone Honed Finish - 200mm Threshold In 24.80 1018 (1018 (3) a3 Granite Stone Honed Finish - 200mm Threshold In 24.80 | | | |
| 1 C | 7] 'S2 Arch p291 & p302 018.5, 2), 1018.5.2, 2) & 1018.6.2, 2) Granite Wall Tile - Dry Cladding The headings for sub-clauses 1018.5, | Please confirm which heading is correct. | Follow plans regarding granite tile installation methodology. BOQ considered dry cladding. | | | |

| | Metro Manila Subway Project Phase 1 PACKAGE CP104: (ORTIGAS NORTH AND ORTIGAS SOUTH) | | | | |
|--|---|---|--|--|--|
| ITEM NO. | REFERENCE/CLAUSE/SECTION | QUERIES | RESPONSE | | |
| S | 2) and 1018.5.2, 2) are Granite Wall File -Dry Cladding. On the other hand, the heading for sub-clause 1018.6, 2) is Granite Wall Tile - Wet Cladding | | Addendum for TS: Update specifications for 1018.6.2.2 to Granite Wall Tile- Dry Cladding | | |
| 47. | FS2 Arch p346 & p381 DWG | May we consider that the cement plaster finish under painting shall be included in pay items 1027(1) Cement Plaster Finish in Bill No. 4? | We consider in BOQ under separate pay item no. 1027 (1) Cement plaster finish. BOQ References: | | |
|] : : : : : : : : : : : : : : : : : : : | BOQ Bill No. 1027(1032 1027.2.1 1032.2.1 Smooth Plaster Cement Finish under Painting Finishes Neither the sub-clauses 1027.2.1 nor 1032.2.1 of the specifications include | | ONS 1027 (1) Cement plaster finish 1027 1027(1) Cement Plaster Finish m2 OSS 1027 (1) Cement plaster finish 1027 (1) Cement plaster finish 1027 (1) Cement Plaster finish 1027 (1) Cement Plaster finish | | |
| 1 | the cement plaster finish under the painting. | | | | |

| nnex " | 'A" | | | |
|--------|-----|--|--|--|
| | | | | |
| | | | | |
| | | | | |
| | | | | |

Metro Manila Subway Project Phase 1 PACKAGE CP104: (ORTIGAS NORTH AND ORTIGAS SOUTH)

| ITEM NO. | [REFERENCE/CLAUSE/SECTION | QUERIES | RESPONSE |
|-------------|--|---|---|
| | DWG Nos. STN-AR-A-ON/OS-9002 | | |
| | indicate 20mm thick plaster under | | |
| | PLT-02 Acrylic Polyurethane Paint | | |
| 48. | TS 02 Arch | We find these mock-up requirements are | Bidder should provide cost for the Mockup requirements |
| | P26 to P34 | unreasonable and excessively expensive for the | specified in the Bidding documents. Size of the mockups |
| | P732 to P747 | Employer. We request that you either remove these | shall be based on the drawing details |
| | C01.3 and | mock-up requirements since each section of the | |
| | Appendix 2 | architecture specification describes mock-up | |
| | Mock-up Requirements | requirement required for the section, or that you | |
| | We have compiled the mock-up | please revise the requirements to the reasonable | |
| | requirements into 3D models in the | sizes and items. | |
| | attachment No. 1 and a facility | Please see Attachments to this RFC Set No 14 | |
| | which will house the mock-ups | relating to this RFC. | |
| | required as per the specifications. It | | |
| | shows that CP 104 contractor will | | |
| | require a three story facility | | |
| | approximately 60m long x 30m wide | | |
| | x 16 high. Some requirements are as | | |
| | follows: | | |
| | 1) Mock-up 2: Mock-up for Ortigas | | |
| | South Entrance require visual mock- | | |

| Metro Manila Subway Project Phase 1 PACKAGE CP104: (ORTIGAS NORTH AND ORTIGAS SOUTH) | | | | | |
|---|---|---------|----------|--|--|
| ITEM NO. | REFERENCE/CLAUSE/SECTION | QUERIES | RESPONSE | | |
| u | p which shall have width and | | | | |
| 10 | ength equal to the actual entrance | | | | |
| b | uilding with the structural frames, | | | | |
| а | set of roof and ceiling, a set of rain | | | | |
| g | utter and downspout, security | | | | |
| s | hutter, stair, handrail, signage, | | | | |
| s | tone walls, floor finishing, flood | | | | |
| b | arrier, railings, handrails, lightning | | | | |
| а | rresters and lighting fittings as | | | | |
| а | ssembled. | | | | |
| 2 |) Mock-up 4: Mock-up for Ortigas | | | | |
| S | bouth Escalator at B1F Level | | | | |
| i | ncluding columns, walls, floors, | | | | |
| g | allery walls, ceiling, doors, shutters, | | | | |
| t | actile, balustrade, glass partition, | | | | |
| s | moke curtain, supply and return air | | | | |
| g | rills, and other required mechanical | | | | |
| a | nd electrical equipment, lighting | | | | |
| f | ittings, signage, etc. | | | | |
| 3 |) Mock-up 5 - Mock-up for Ortigas | | | | |
| S | outh Escalator at B3F Level | | | | |

| | Metro Manila Subway Project Phase 1 PACKAGE CP104: (ORTIGAS NORTH AND ORTIGAS SOUTH) | | | | | |
|-------------|---|---------|----------|--|--|--|
| ITEM NO. | REFERENCE/CLAUSE/SECTION | QUERIES | RESPONSE | | | |
| iı | ncluding columns, walls, floors, | | | | | |
| g | allery walls, ceiling, doors, shutters, | | | | | |
| ta | actile, balustrade, glass partition, | | | | | |
| s | moke curtain, supply and return air | | | | | |
| g | rills, and other required mechanical | | | | | |
| a | nd electrical equipment, lighting | | | | | |
| fi | ttings, signage, etc. | | | | | |
| 4 |) Mock-up 1 - Mock-up for Ortigas | | | | | |
| S | outh Toilet and Ticket Office; A | | | | | |
| fi | all-scale mock-up of a room of each | | | | | |
| te | oilet and ticket to contain all | | | | | |
| a | rchitectural elements and a set of | | | | | |
| n | nechanical and electrical fittings | | | | | |
| iı | ncluding, but not limited to, water | | | | | |
| c | loset, lavatory-booth, washbasin | | | | | |
| с | ounter, vanity mirror, faucet, and | | | | | |
| li | ghting fittings. | | | | | |
| 5 |) Ventilation Tower Louvers at | | | | | |
| E | ntrance 2 in Mock-up 2 - Mock-up | | | | | |
| fe | or Ortigas South Entrance - 1 | | | | | |
| (| 1) A full-scale mock-up of a set of | | | | | |

| ITEM NO. | REFERENCE/CLAUSE/SECTION | QUERIES | |
|-------------|--------------------------------------|---|--|
| | | QUERTES | RESPONSE |
|] | ouvers | | |
| | 6) Signage fixture prepared for each | | |
| (| of the elements of the signage works | | |
| i | ncluding the under laying steel | | |
| \$ | structure, other architectural | | |
| (| components, and mechanical and | | |
| (| electrical components involved | | |
| 49. | VI TS2 | We received the following comments from the | Please check with other suppliers as stated in specs |
| 2 | 280 | specified supplier: | 'approved equal or better' |
| | 1018.2.1 4) | 1. Ruvido Grigio tile is ceramic tile. | |
| | CTL-01 Wall Tile | 2. They do not recommend to use for the size 1200 x | |
| : | Size: 1200 x 600 x 10mm. | $600 \ge 10$ mm because the standard size of this tile is | |
| (| Color: Mozzaico Ruvido Grigio or as | $300 \ge 300 \ge 10$ mm. They doubt if the manufacturer | |
| : | approved equal or better. | would produce this size for Ruvido Grigio tile which | |
| | | is ceramic tile that is not strong such as porcelain | |
| | | tile. They cannot communicate with the | |
| | | manufacturer due to Chinese New Year holidays as | |
| | | of this writing. | |
| | | Please allow us to use the size of 300 x 300 x 10mm, | |
| | | or specify other tiles from porcelain tiles. | |
| | | 3. Mechanical, Electrical and Plumbing | |

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| Metro Manila Subway Project Phase 1 PACKAGE CP104: (ORTIGAS NORTH AND ORTIGAS SOUTH) | | | | | |
|---|--|--|--|--|--|
| ITEM NO. | REFERENCE/CLAUSE/SECTION | QUERIES | RESPONSE | | |
| | Technical Specifications 3: Mechanical, Electrical, Plumbing: Section 1241.2.3 | Please clarify the starter for the controller to be used if wye-delta closed transition or wye-delta open transition. | If it is inertial type of load, open transition type shall be used. If it is frictional type of load, then closed transition shall be used. | | |
| N S I | Technical Specifications 3: Mechanical, Electrical, Plumbing: Sections 1121 Bill of Quantities, Bill 5A and Bill 5B, Item 1121 (a), 1121 (b), 1121 (c) | As per technical specifications, low voltage power cables shall be grade fire resistant type with low smoke and fume (LSF) and zero halogen and XLPE insulated. However, in the Bill of Quantities, low voltage power cables are XHHW. Kindly clarify which will prevail? | XLPE will prevail. BOQ followed schematic diagram. Please confirm what will govern. Kindly refer to below plans. MEP Drawings and BOQ were amended in GBB10 Insticuted sq.mm Cu. XLPE + Insticuted sq.mm Cu. XLPE CPC CABLE ID CNE-1.9 | | |
| | | | Important Construction Important Construction Important Constend C | | |

Annex "A"

| | Metro Manila Subway Project Phase 1 PACKAGE CP104: (ORTIGAS NORTH AND ORTIGAS SOUTH) | | | | | | |
|-------------|---|---|--|--|--|--|--|
| ITEN NO. | | QUERIES | RESPONSE | | | | |
| 52. | Technical Specifications 3: | Please confirm if no duct smoke detectors are to be | Required Duct Smoke Detectors Near Supply & return air | | | | |
| | Mechanical, Electrical, Plumbing: | considered. No duct smoke detector units were on | ducts of AHU's. | | | | |
| | Sections 1123.3.3 | FDAS or Mechanical Plans but mentioned in the | Refer to the latest MEP Drawings & BOQ | | | | |
| | | technical specifications. | | | | | |

| | Volume III Part 2 : Works Requirements Section VI Works Requirements Employer's Drawings (DRW) | | | | | | |
|-----|---|--|---|--|--|--|--|
| 53. | Ortigas North Station STP-MEP-ELL-ON-3111 STN-MEP-ELL-ON-3115 STN-MEP-ELL-ON-3122 STN-MEP-ELL-ON-3124 STN-MEP-ELL-ON-3131 STN-MEP-ELL-ON-3134 Bill of Quantities Bill 5A, Item 1113 (1bd and lbe) Ortigas South Station STN-MEP-ELL-OS-3111 STN-MEP-ELL-OS-3113 STN-MEP-ELL-OS-3114 STN-MEP-ELL-OS-3122 | Please provide Lighting Control Panel Load Schedule for both Station. | LCP shall be consisting of relay to operate presence detector of lighting circuits fed from various lighting DBs. Please note there shall not be any different lighting circuit inside the LCP. Lighting DB schedules is included under Electrical drawings (OS-2007 to 2052 and ON-2007 to 2046). Bidder also needs to refer to the latest BOQ Lighting ControlPanel(LCP); including Busbar, Neutral bus, selector switch, contactors, relays, integral surge protection devices (SPD), phase indicating lights, power meters and auxilliary contacts for BMS interconnection and all necessary accessories in accordance with the manufacturer's instructions and as shown in drawings with reference STN-MEP-ELL-OS-3100 to 3244 | | | | |


Annex "A"


| <u>annex</u> | Metro Manila Subway Project Phase 1 PACKAGE CP104: (ORTIGAS NORTH AND ORTIGAS SOUTH) | | | | | | |
|--------------|--|--|--|--|--|--|--|
| ITEM NO. | REFERENCE/CLAUSE/SECTIO | ON QUERIES | RESPONSE | | | | |
| 5 | STN-MEP-ELL-OS-3124 STN-MEP-ELL-OS-3131 STN-MEP-ELL-OS-3134 Ortigas North StationSTP-MEP- ELL-ON-3111STN-MEP-ELL- ON-3211Ortigas South StationSTN-MEP-ELL-OS- 3114STN-MEP-ELL-OS-3214 | Kindly provide details for this panel. | Outgoing distribution of Retail DB is unknown only 6 Way TPN DB has been considered. | | | | |
| 55. 5 | STN-MEP-PLD-OS-3231 | Kindly verify/provide drainage piping layout and sizes of floor drain located near the janitor space (Grid B-5) at Platform Level Ortigas South Station. | Pipe routing for platform level FD comes in Under- platform level, Under-platform level is under Civil scope which is stated in Drainage Layout & Schematic. | | | | |

Page 38 of 60


| Annex | Metro Manila Subway Project Phase 1 PACKAGE CP104: (ORTIGAS NORTH AND ORTIGAS SOUTH) | | | | | |
|-------------|---|--|---|--|--|--|
| ITEM NO. | REFERENCE/CLAUSE/SECTIO | N QUERIES | RESPONSE | | | |
| | | JANITOR SPACE | | | | |
| 56. | STN-MEP-PLD-OS-3233 | Kindly verify/provide drainage piping layout and size of floor drain located at Ortigas South Station near Staircase 6 (Grid B-19) at Platform Level. | Pipe routing for platform level FD comes in Under-platform level, Under-platform level is under Civil scope which is stated in Drainage Layout & Schematic | | | |
| 57. | STN-MEP-PLD-OS-3234 | Kindly verify/provide drainage piping layout and size of floor drain located at Ortigas South Station near Access Hatch (Grid B-32) at Platform Level. | Pipe routing for platform level FD comes in Under- platform level, Under-platform level is under Civil scope which is stated in Drainage Layout & Schematic | | | |

| | | Metro Manila Subway Project Pha PACKAGE CP104: (ORTIGAS NORTH AND ORTI | | | |
|-------------|--|--|--|--|--|
| ITEM NO. | 1 REFERENCE/CLAUSE/SECT | ION QUERIES | RESPONSE | | |
| | | FD ACCES HATCH ABOVE | | | |
| 58. | STN-MEP-PLD-OS-3221 | Kindly provide/verify the drainage piping layout from the 300mm wide drain channel located at Ortigas South Station Mezzanine Level (Grid A-7) | There will be no piping to drain, water from 300mm wide drain channel. From 300mm drain channel it will goes to nearby FD directly | | |
| 59. | STN-MEP-PLD-ON-2201 STN-MEP-PLD-OS-2201 | Kindly verify what type of scupper is shown. Also, provide detailed drawing. | Details of Scupper drain is in Arch. Scope, Refer STN-AR- A-ON-9180 for details | | |

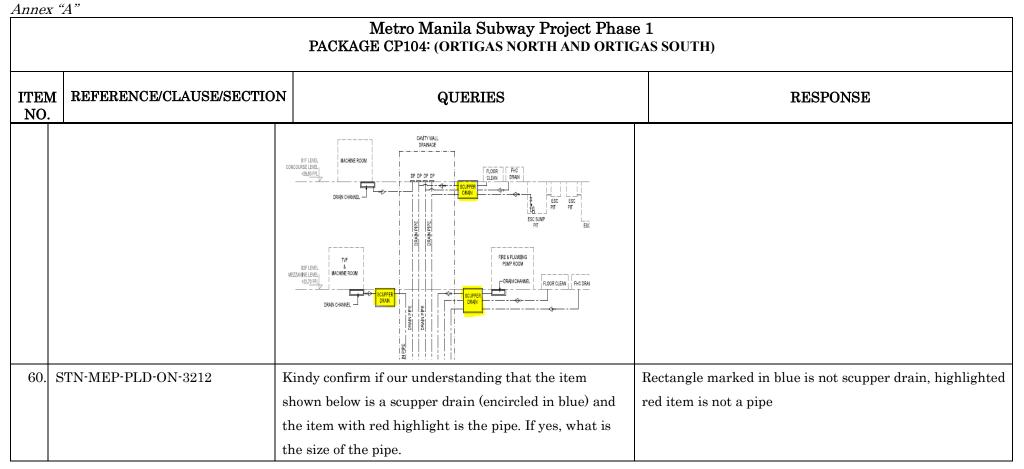

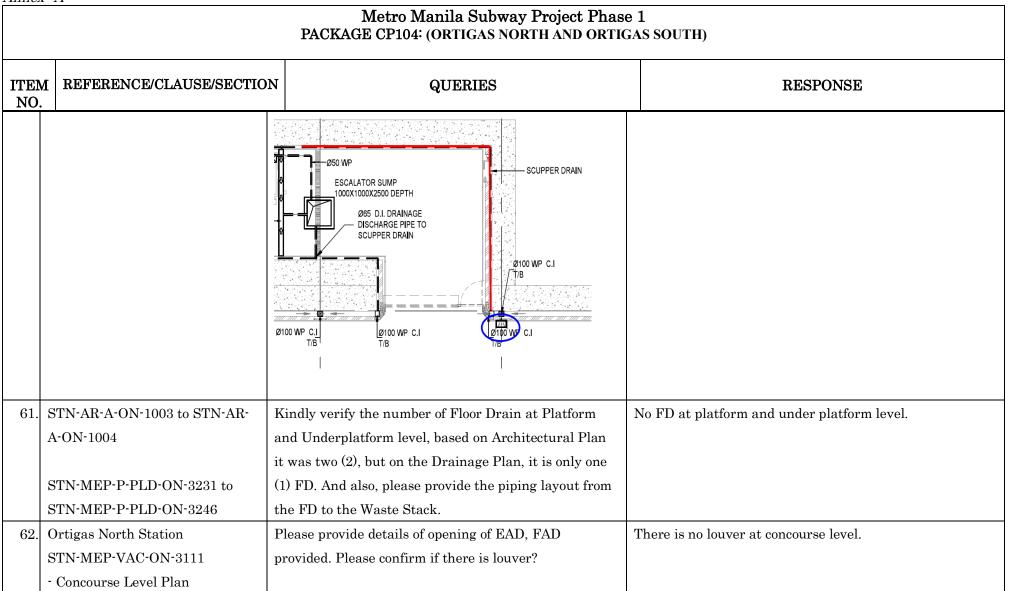

| | Metro Manila Subway Project Phase 1 PACKAGE CP104: (ORTIGAS NORTH AND ORTIGAS SOUTH) | | | | | | | |
|-------------|---|---|---|--|--|--|--|--|
| ITEM NO. | REFERENCE/CLAUSE/SECTION | QUERIES | RESPONSE | | | | | |
| | | 0 EAD DEAD DEAD DEAD DEAD DEAD DEAD PLENUM SIZE-4000 (2150 x 2000 (H) PLENUM SIZE-2200 x 140 0 x 2000 (H) D 3200 X 300 FADEAD MULTIPURPOSE | | | | | | |
| 63. | | In reference to Escalator Rise, the plan lay-out shows 12.15meters of rise. However, in the same plan, the | Escalator rise shall be 12150 mm | | | | | |
| | | escalator summary shows an escalator rise of | Bidder to refer to the information below, And bidder to | | | | | |
| | | 11.25meters. Which will prevail? | understand the drawing before making such query. | | | | | |

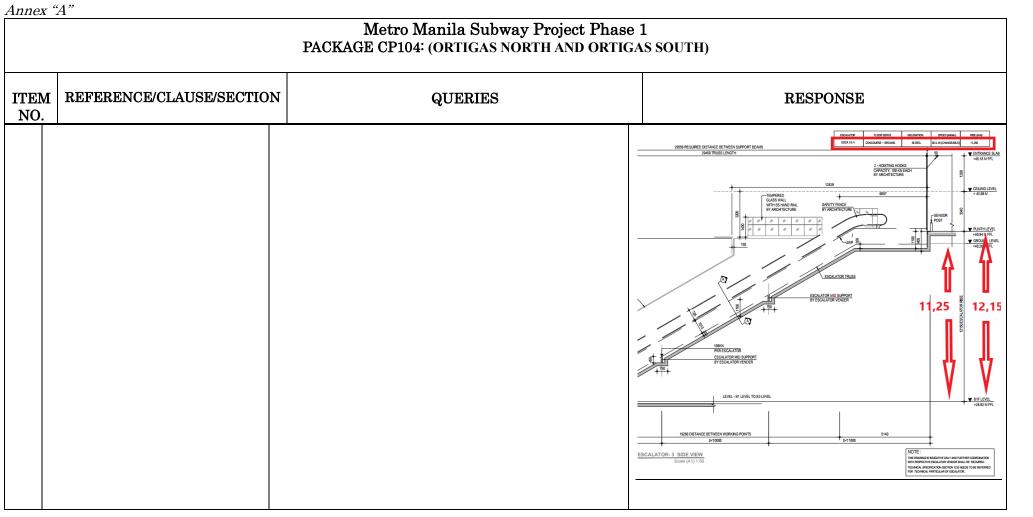

| Annex | "A | , |
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| | Metro Manila Subway Project Phase 1 PACKAGE CP104: (ORTIGAS NORTH AND ORTIGAS SOUTH) | | | | | |
|-------------|--|--|---|--|-----------------------|---|
| ITEN NO. | REFERENCE/CLAUSE/SECTIO | N QUERIES | | | RESPONSE | |
| 64. | Bill of Quantities Bill 5B, Item 1233 (1) MEP-VAC-OS-3825, MEP-VAC- OS-3826, MEP-AR-A-OS-1001 | prevail: Description South Station ESCA 2 Step width | y which of the fo As per MEP Plan 1010 mm | As per Architectural Plan 1000 mm | As per BOQ 1550 mm | NOTE: This DRAWNG IS NOLCATIVE ONLY AND FURTHER COORDINATION WITH RESPECTIVE ESCALATOR VENDOR SHALL BE REQUIRED. TECHNICAL SPECIFICATION SECTION 123 NEEDS TO BE REFERRED FOR TECHNICAL SPECIFICATION SECTION 123 NEEDS TO BE REFERRED FOR TECHNICAL PARTICULAR OF ESCALATOR. METRO MANILA SUBWAY PROJECT DATE PHASE1 BALL E PACKAGE CP 104 SHEET NA. Ortigas South Station STI-MEP-VAC-OS-3827 DRG No. STI-MEP-VAC-OS-3827 DRG N. STI-MEP-VAC-OS-3827 DRG N. STI-MEP-VAC-OS-3827 DRG No. STI-MEP-VAC-OS-3827 |
| 65. | Bill of Quantities Bill 5B, Item 1233 (1) | Please clarify prevail: | Please clarify which of the following conflict items shall prevail: | | | Escalator step width shall be minimum 1000 mm. However, BOQ description provides total width of |

Annex "A"

| Annex | Metro Manila Subway Project Phase 1 PACKAGE CP104: (ORTIGAS NORTH AND ORTIGAS SOUTH) | | | | | | | |
|-------------|---|---|-----------------|---------------------------------|---|---|--|--|
| ITEM NO. | REFERENCE/CLAUSE/SECTIO | N | QUERIES | | | RESPONSE | | |
| | MEP-VAC-OS-3828, MEP-VAC- | Description | As per MEP Plan | As per Architectural Plan | As per BOQ | escalator requirements including housing. Please refer to the MEP Plan Drawing below | | |
| | OS-3829, STN-AR-A-OS-1003 | South Station ESCA 3 Step 1010 mm 1 width | 1000 mm | 1550 mm | METRO MANILA SUBWAY PROJECT August 2020 PHASE1 SCALE AS SHOWN | | | |
| | | | | | • | Ortigas South Station Escalator No. 3 (Sheet 2) | | |
| | | | | | | NOTING WOVING WOVING <td c<="" th=""></td> | | |

| | Metro Manila Subway Project Phase 1 PACKAGE CP104: (ORTIGAS NORTH AND ORTIGAS SOUTH) | | | | | |
|-------------|---|---------------|--|--|--|--|
| ITEM NO. | REFERENCE/CLAUSE/SECTION | QUERIES | RESPONSE | | | |
| | | Page 47 of 60 | NOTE : THIS DRAWING IS INDICATIVE ONLY AND FURTHER COORDINATION WITH RESPECTIVE ESCALATOR VENDOR SHALL BE REQUIRED. TECHNICAL SPECIFICATION SECTION 1233 NEEDS TO BE REFERRED FOR TECHNICAL PARTICULAR OF ESCALATOR. DURING CONSTRUCTION, ARCHITECTURE (STRUCTURE) CONTRACTOR NEED TO FURTHER COORDINATION WITH SELECTED ESCALATOR VENDOR FOR FIXING ARRANGEMENT OF MOUNTING PLATE. | | | |


| Annex | "A | , |
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| | | |

| | | Metro Mani PACKAGE CP104: (OR | | Project Phas TH AND ORTIC | | |
|-------------|---|--|---|--|--|--------------------------|
| ITEM NO. | | | | | RESPONSI | 6 |
| 1 M C | Bill of Quantities Bill 5B, Item 1233 (1) MEP-VAC-OS-3831, MEP-VAC- OS-3832, STN-AR-A-OS-1002, STN-AR-A-OS-1003 | Please clarify which of the for prevail: Description As per MEP Plan South Station ESCA 4-5 Step width | llowing confl As per Architectural Plan 1000 mm | ict items shall As per BOQ 1550 mm | METRO MANILA SUBWAY PROJECT PHASE1 PACKAGE CP 104 Ortigas South Station Escalator No. 3 (Sheet 3) Escalator step width shall be minim However, BOQ description provides escalator requirements including hor | total width of |
| 1 S A | Bill of Quantities Bill 5B, Item 1233 (1)STN-MEP-VAC-OS-3834, STN-MEP-VAC-OS-3835, STN- AR-A-OS-1004 to STN-AR-A-OS- 1005 | Please clarify which of the fo prevail: | llowing confl | ict items shall | Escalator step width shall be minim However, BOQ description provides escalator requirements including ho Please refer to the MEP Plan Drawin | total width of using. |


| | Metro Manila Subway Project Phase 1 PACKAGE CP104: (ORTIGAS NORTH AND ORTIGAS SOUTH) | | | | | | |
|-------------|---|--|-----------------|---------------------------------|------------|---|--|
| ITEM NO. | REFERENCE/CLAUSE/SECTION | ſ | QU | JERIES | | RESPONSE | |
| NO. | | Description South Station ESCA 6 - 9 Step width | As per MEP Plan | As per Architectural Plan | As per BOQ | Image: Note of the second s | |
| | | | | | | WITH RESPECTIVE ESCALATOR VENDOR SHALL BE REQUIRED. TECHNICAL SPECIFICATION SECTION 1233 NEEDS TO BE REFERRED | |

| Annex | " A " |
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| | Metro Manila Subway Project Phase 1 PACKAGE CP104: (ORTIGAS NORTH AND ORTIGAS SOUTH) | | | | | | |
|-------------|---|--|---|--|--|--|--|
| ITEM NO. | REFERENCE/CLAUSE/SECTIO | N QUERIES | RESPONSE | | | | |
| | | | METRO MANILA SUBWAY PROJECT PHASE1 DATE August 2020 PACKAGE CP 104 SCALE AS SHOWN PACKAGE CP 104 SHEET No. Ortigas South Station Escalator No. 6,7,8 & 9 (Sheet 3) DRG No. STN-MEP-VAC-OS-3835 | | | | |
| 68. | STN-CE-OS-0436 | Based on the bid drawings provided. We noticed that there are no details of stirrups/ ties for Ventilation Shaft, also Slab and Wall reinforcement details of Entrance 01. May we request for the detailed drawings/blow-up reinforcement. | There are no detail for stirrups as the detail design still has not completed yet. For bidding pricing, please refer to the quantity of Steel bar in BOQ 2008(5) for each station. | | | | |

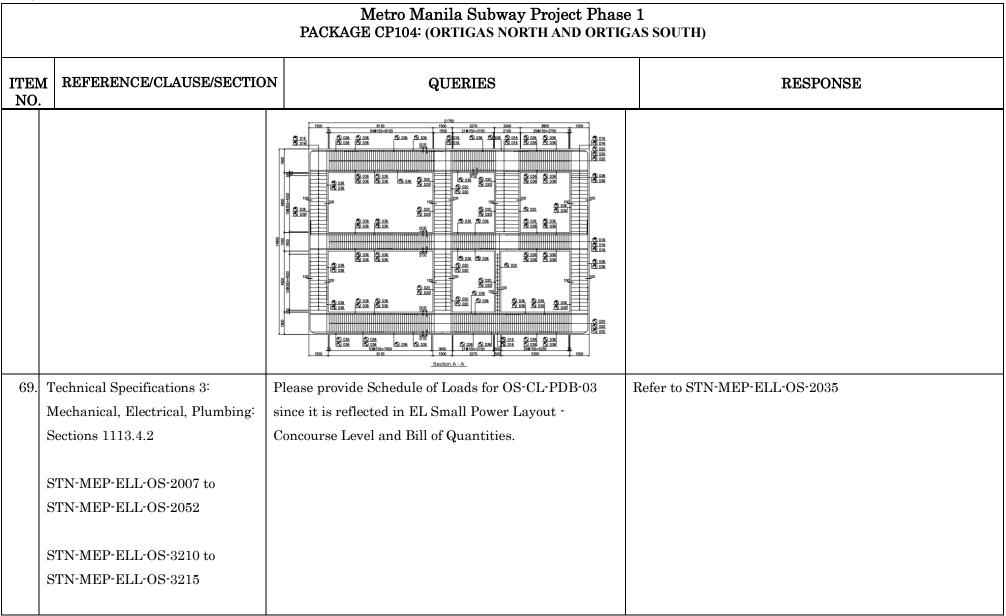

| | Metro Manila Subway Project Phase 1 PACKAGE CP104: (ORTIGAS NORTH AND ORTIGAS SOUTH) | | | | | | | |
|-------------|---|---|--|--|--|--|--|--|
| ITEN NO. | | N QUERIES | RESPONSE | | | | | |
| | Bill of Quantities 1113 5B, Item 1113 | | | | | | | |
| 70. | STN-MEP-ELL-CWD-1004 | As per our understanding this figure 7.13 is a stand alone setup for occupancy sensor, while figure 7.03 is a digital system setup. Please provide the zones applicable for each setup. $\qquad \qquad $ | There are two control points of lighting distribution of a level one at right side electrical room another one at left side. However, presence detector coverage 7m for small room 14m bigger room to switch on/off light fixtures. | | | | | |
| 71. | STN-MEP-BMS-CWD-1013 STN-MEP-BMS-CWD-1014 | Please provide sequence of operation for the Tunnel Ventilation Fan and Motorized Smoke and Fire Damper. | Tunnel Ventilation operation Conditions are shown in the Drawings: STN-MEP-BMS-OS-3761,3762,3763 & STN- MEP-BMS-ON-3771,3772,3773 | | | | | |
| 72. | STN-MEP-VAC-CWD-0104 | In reference to the detail sheet for Air Handling Unit with mixing box, what is the abbreviation of MMCD? | MEP drawing was updated to show the Air Handling Unit with mixing box. Please refer to STN-MEP-VAC-CWD-1106-0. | | | | | |

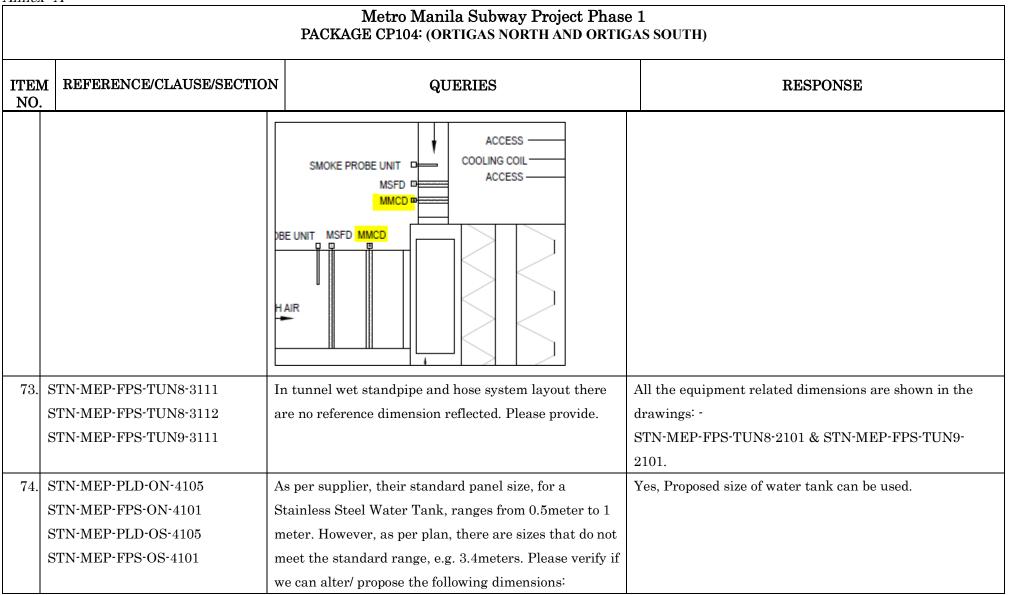


Annex "A"

| | | | co Manila Subv 104: (ORTIGAS 1 | | | | |
|-------------|--------------------------|--|---|--|-----------------------------|------|--|
| ITEM NO. | REFERENCE/CLAUSE/SECTION | | QUERIES | | | | RESPONSE |
| | 1 | Item Description | Original Dimension L(m) X W(m) x H(m) | Proposed Tar L(m) X W(| | | |
| | | 1 Domestic Water Tank 1 2 Domestic Water Tank 2 3 Make Up Water Tank 1 | 7m x 3m x 3.4m 7m x 3m x 3.4m 8m x 2.4m x 3.4m | 7m x 3m 7m x 3m 8m x 2.5i | x 3.5m n x 3.5r | n | |
| | | 4 Make Up Water Tank 2 5 Sewage Tank 1 6 Sewage Tank 2 7 Fire Water Tank 1 | 8m x 2.4m x 3.4m 2m x 2m x 2m 2m x 2m x 2m 17.3m x 2.44m x 3.45m | 8m x 2.5i 2m x 2i 2m x 2i 17m x 2.5 | m x 2m m x 2m | | |
| | | 8 Fire Water Tank 2 ORTIGAS SOUTH 1 Domestic Water Tank 1 2 Domestic Water Tank 2 | e Water Tank 2 17.3m x 2.44m x 3.45m S SOUTH mestic Water Tank 1 7.24m x 3m x 3.4m | | m x 3.5 x 3.5m x 3.5m | | |
| | | 3 Make Up Water Tank 1 4 Make Up Water Tank 2 5 Sewage Tank 1 | 8m x 3m x 3.4m 6m x 4m x 3.4m 6m x 4m x 3.4m 2m x 2m x 2m | 6m x 4m 6m x 4m 2m x 2 | x 3.5m x 3.5m | | |
| | | 6 Sewage Tank 2 7 Fire Water Tank 1 8 Fire Water Tank 2 | 2m x 2m x 2m 7.95m x 5.3m x 3.4m 12.58m x 3m x3.4m | 2m x 2 8m x 5.5 12.5m x 3 | m x 3.5r | | |
| | - | In reference to Bid I quantity for Water I | | | | e | BOQ updated following latest equipment schedule. Please see screenshot below. |
| | | match the equipmen quantity will prevai | | se clarify v | whicł | 1 | OSS - BOQ |
| | | As per BOQ: | | | | | Water heater; complete with driving motor, all necessary accessories and connection, electrical/control wirings, conduits and complete as in the equipment schedule and as described |
| | | | ESCRIPTION | | UNIT | QTY | 1237(5) Electric water heater; 25L capacity; horizontal wall mounted, 2kW; 3ph; 380V; 60Hz, ref SL no.1 2 pc 1237(5) Electric water heater; 15L capacity; horizontal wall mounted, 1.5kW; 3ph; 380V; 60Hz, ref SL no.2 to 4 5 pc |
| | | Electric water heater; 15L capaci 380V; 60Hz, ref SL no.2 to 4 | ity; norizontai wali mouhted, | 1.экw; зрп; | рс | 5.00 | OSS - Equipment Schedule |

| TEM NO. | REFERENCE/CLAUSE/SECTIO | N | QUERI | ΈS | | - | RESPONSE | | | |
|------------|-------------------------|------------|------------------|------------------|---------|--|-----------------------------|---------------|---|----|
| | | As per Equ | ipment Schedule: | | SL. NO. | LOCATION | WATER HEATER NO. | | | |
| | | SL. NO. | LOCATION | WATER HEATER NO. | 1. | SECURITY STAFF SHOWER (M) & (F) | 2 | | | |
| | | 2. | FIRST AID ROOM | 1 | 2. | FIRST AID ROOM | 1 | | | |
| | | 3, | STAFF TOILET (M) | 1 | 3. | PUBLIC TOILET (M) | 1 | | | |
| | | | | | 4. | PUBLIC TOILET (F) | 1 | | | |
| | | 4. | STAFF TOILET (F) | 1 | 5. | STAFF TOILET (M) | 1 | | | |
| | | | | | 6. | STAFF TOILET (F) | 1 | | | |
| | | | | | ONS - | BOQ | · · · · · | | | |
| | | | | | | Water heater; complete with and connection, electrical/c in the equipment schedule a | ontrol wirings, conduits ar | | | 1 |
| | | | | | 1237(5) | Electric water heater; 25L 3ph; 380V; 60Hz, ref SL no | capacity; horizontal wall m | nounted, 2kW; | 2 | ро |

| | Metro Manila Subway Project Phase 1 PACKAGE CP104: (ORTIGAS NORTH AND ORTIGAS SOUTH) | | | | | | |
|-------------|---|---|---------|---------------------------------|------------------|--------------------|--|
| ITEM NO. | REFERENCE/CLAUSE/SECTIO | N QUERIES | | R | ESPONSE | | |
| | | | SL. NO. | LOCATION | WATER HEATER NO. | - | |
| | | | 1. | SECURITY STAFF SHOWER (M) & (F) | 2 | | |
| | | | 2. | FIRST AID ROOM | 1 | | |
| | | | 3. | MULTIPURPOSE TOILET (M) | 1 | | |
| | | | 4. | MULTIPURPOSE TOILET (F) | 1 | - | |
| | | | 5. | STAFF TOILET (M) | 1 | | |
| | | | 6. | STAFF TOILET (F) | 1 | | |
| 76. | STN-MEP-VAC-ON-3123 and | Please verify if there is a need for airconditioning | Railv | vay System is differen | t scope. | | |
| | STN-MEP-VAC-ON-3124 | ductworks and air terminals for the following Ceiling | Duct | work and Air termina | als details sha | all be updated "by | |
| | | Concealed unit: | contr | actor" once system la | youts are ava | ailabe. | |
| | | 1.ON- MZ- IU- 2A/2B (2 UNITS) | | | | | |
| | | 2.ON-MZ- IU-8A/8B/8C/8D (4 UNITS) | Typic | al detail VAC-CWD | 1104 should i | nclude the detail. | |
| | | 3.ON-MZ-IU-10A/10G (7 UNITS) | Lum | osum line items shall | be included | in the BOQ for the | |
| | | | tenta | tive ductwork inside | system room | s. | |
| | | If yes, please provide detailed ducting layout with | | | | | |
| | | specific Air terminal Grille Size. | | | | | |

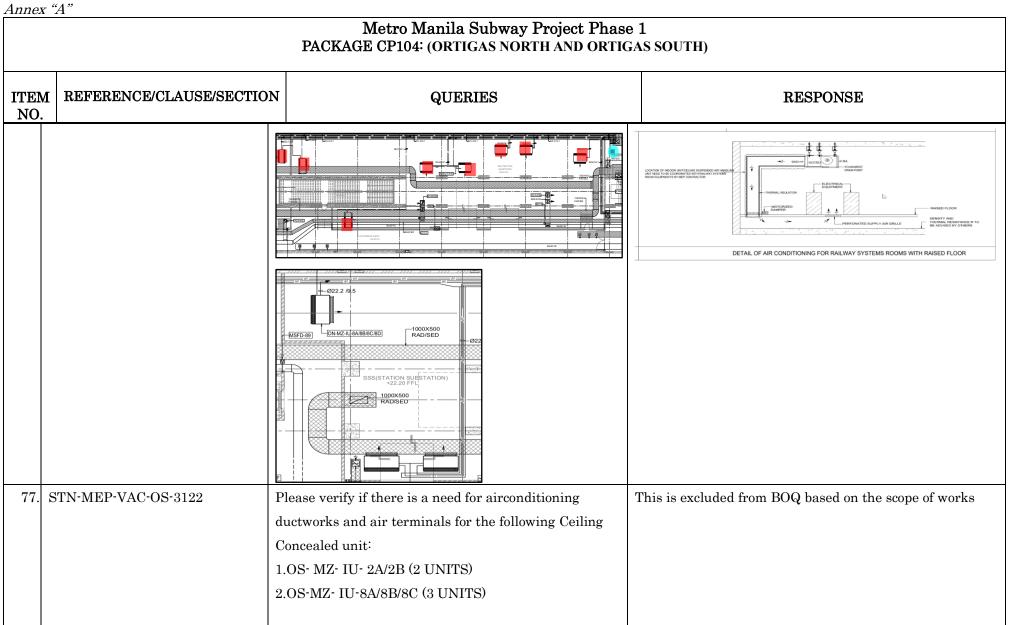

| | Metro Manila Subway Project Phase 1 PACKAGE CP104: (ORTIGAS NORTH AND ORTIGAS SOUTH) | | | | | | |
|-------------|---|---|----------|--|--|--|--|
| ITEM NO. | REFERENCE/CLAUSE/SECTION | QUERIES | RESPONSE | | | | |
| | | If yes, please provide detailed ducting layout with specific Air terminal Grille Size. | | | | | |
| | | PRD-09 PRD-09 PRD-09 UP FAG-15 Ø15.9/9.5 OS-MZ-IU-2A/2B VPS ROOM 100 Sqm Ø28.6/15.9 S | | | | | |

| | Metro Manila Subway Project Phase 1 PACKAGE CP104: (ORTIGAS NORTH AND ORTIGAS SOUTH) | | | | | | |
|-------------|---|--|----------|--|--|--|--|
| ITEM NO. | REFERENCE/CLAUSE/SECTION | QUERIES | RESPONSE | | | | |
| | | OS-MZ-IU-3A/8B/8C OS-MZ-IU-3A/8B/8C I6000X800 CUTOUT HN FLOOR FOR RETURN AIR DUCT Y22.83 FFL FAG-12 SSS (STATION) SUBSTATION) 190 Sqm Ø34.9/19.1 Ø22.6/9.5 | | | | | |

| | Volume IV. Part 3 - Conditions of Contract and Contract Forms | | | | | | | |
|-----|---|--|---|--|--|--|--|--|
| 78. | Section VIII Particular Conditions | May the Employer and the Contractor agree to an | It would be acceptable if the Bidder proves the PI | | | | | |
| | (PC) | appropriate insurance in case the PI Insurance for | Insurance for major temporary works not accepted by the | | | | | |
| | PC-10 | major temporary works not accepted by the global | global reinsurance market | | | | | |
| | 6. Professional Indemnity | reinsurance market? | | | | | | |
| | Insurance | | | | | | | |

| | Metro Manila Subway Project Phase 1 PACKAGE CP104: (ORTIGAS NORTH AND ORTIGAS SOUTH) | | | | | | |
|-------------|---|-----------|----------|--|--|--|--|
| ITEN NO. | | N QUERIES | RESPONSE | | | | |
| | GBB No.6 Item no.21 | | | | | | |